




Location Plan NTS



Location Plan NTS



Aerial View of Subject Site 2-6 Bold & 80-82 Cowper Street, Granville

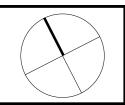

All work to be carried out accordance with BCA, AS & Counc conditions.

conditions.

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construction & no allowance has been made for shrinkage or milling position of electrical meter to be determined on site in accordance to the turret position front garden tap on meter.

Energy Smart Design: AAA rated water conservation devices include rainwater tanks shower heads, water tap flow regulators, dual flush toliets & cistems & compliant hot water systems with minimum green house score of 3.5 stars are to be used in this development. All occupants are encouraged to use AAA rated dish washing machines with front loading where possible.

Notes:

AAC Veneer Insulation R1.5 Bulk

Metal Cladding Insulation R1.5 Bulk

Concrete Roof Insulation R1.0 EPS

Concrete Slabe Above Level 1 Insulation

R1.0 EPS

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All Bathroom/Ritchen Taps 4 Stars
All Toilet Flushing Systems 4 Stars
All Shower Heads 3 Stars
Gas Instantaneous 5 Star
Healting/Cooling 1 phase 1 Star System
Gas Cooktop & Electric Oven

Gas Cooktop & Electric Oven

project:
Demolition &
Construction of a 17
storey mixed use
development
containing 92 units with
2 tenancies over
basement parking

client:
Designer Home
Constructions

Council
City of Parramatta
Council

Drawing title:
Site Plan Analysis


Designed


J.Johannsen/A.Winton M.Trinh/J.Ellis


Issue/Stage:
Issue C - DA
Paper/Scale:
A3/1:1000


Date: 9/08/2017

Job #: Dwg #: **28049 08**

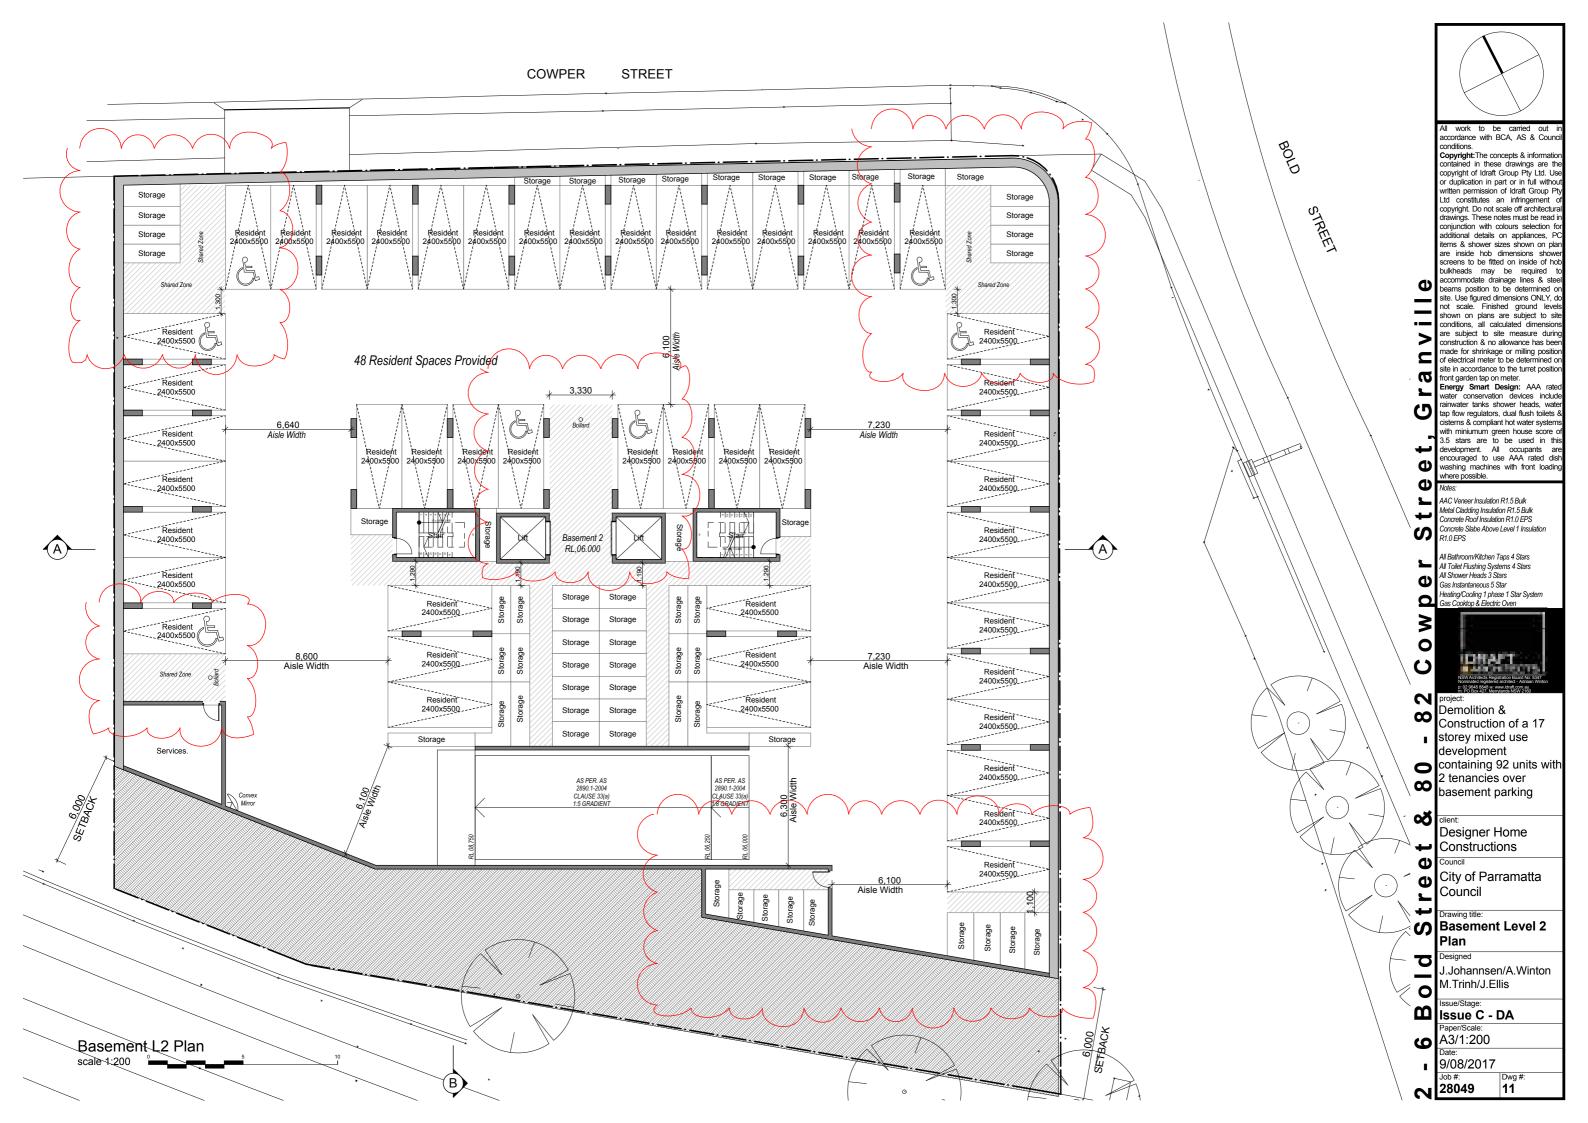


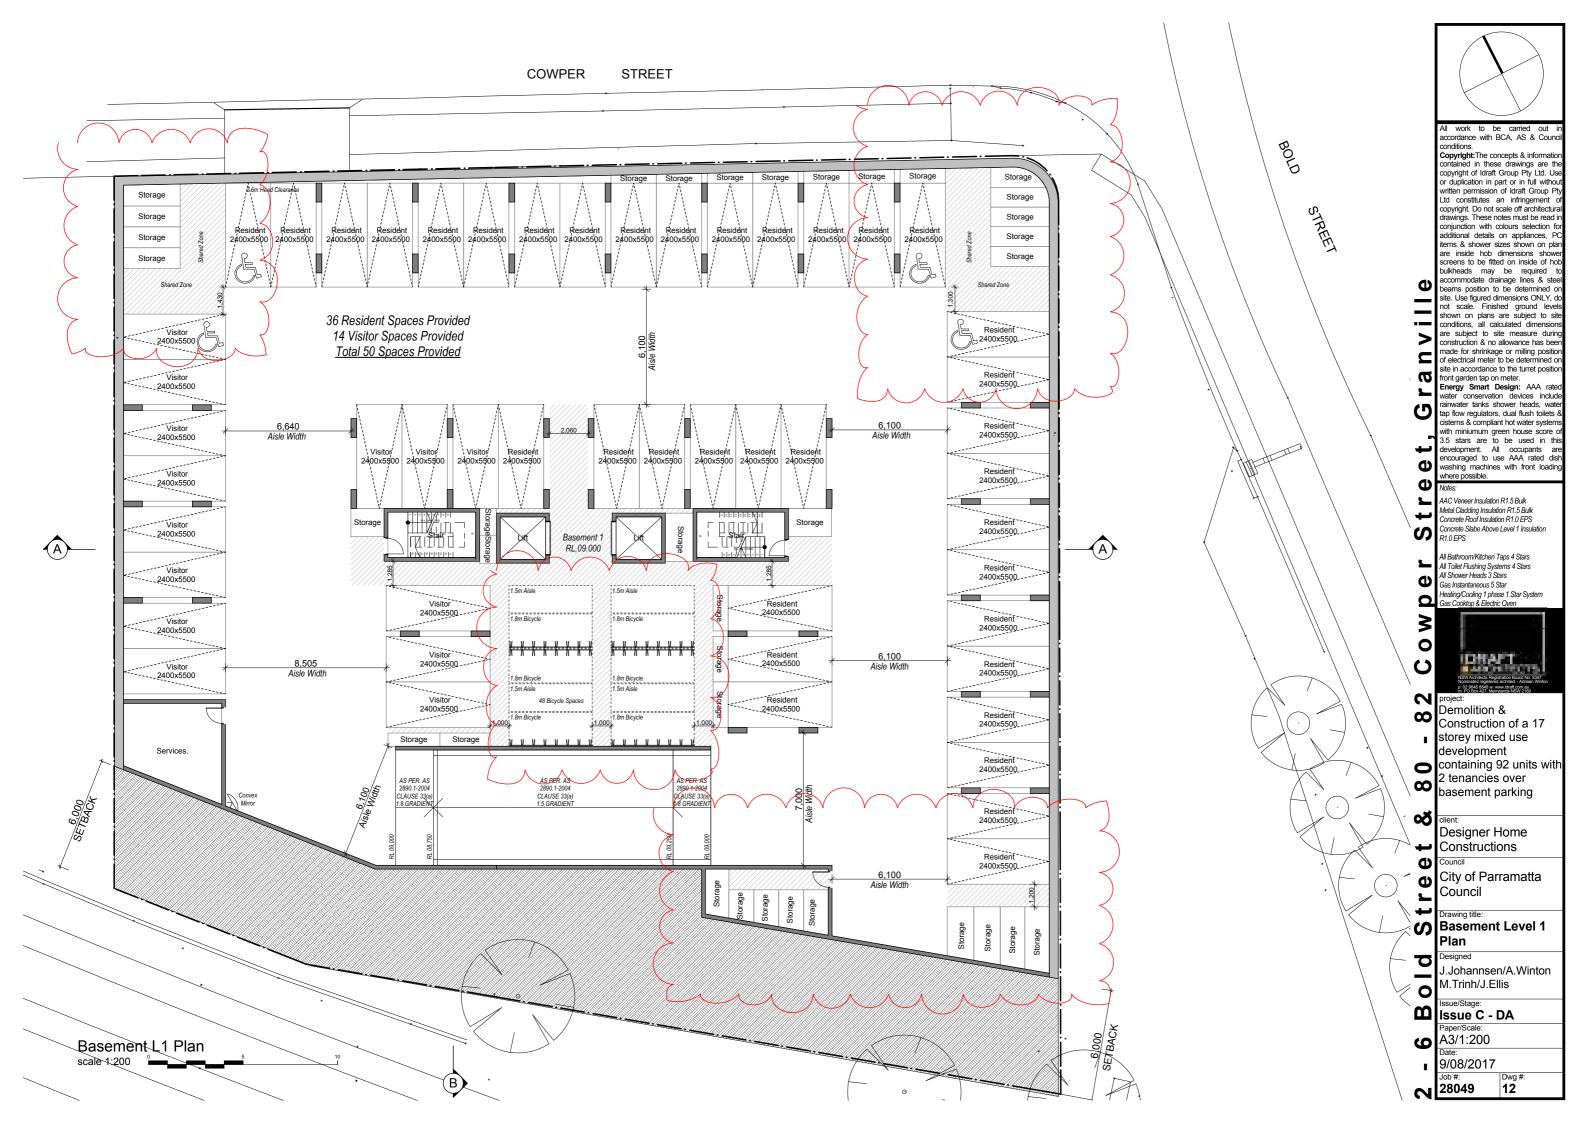


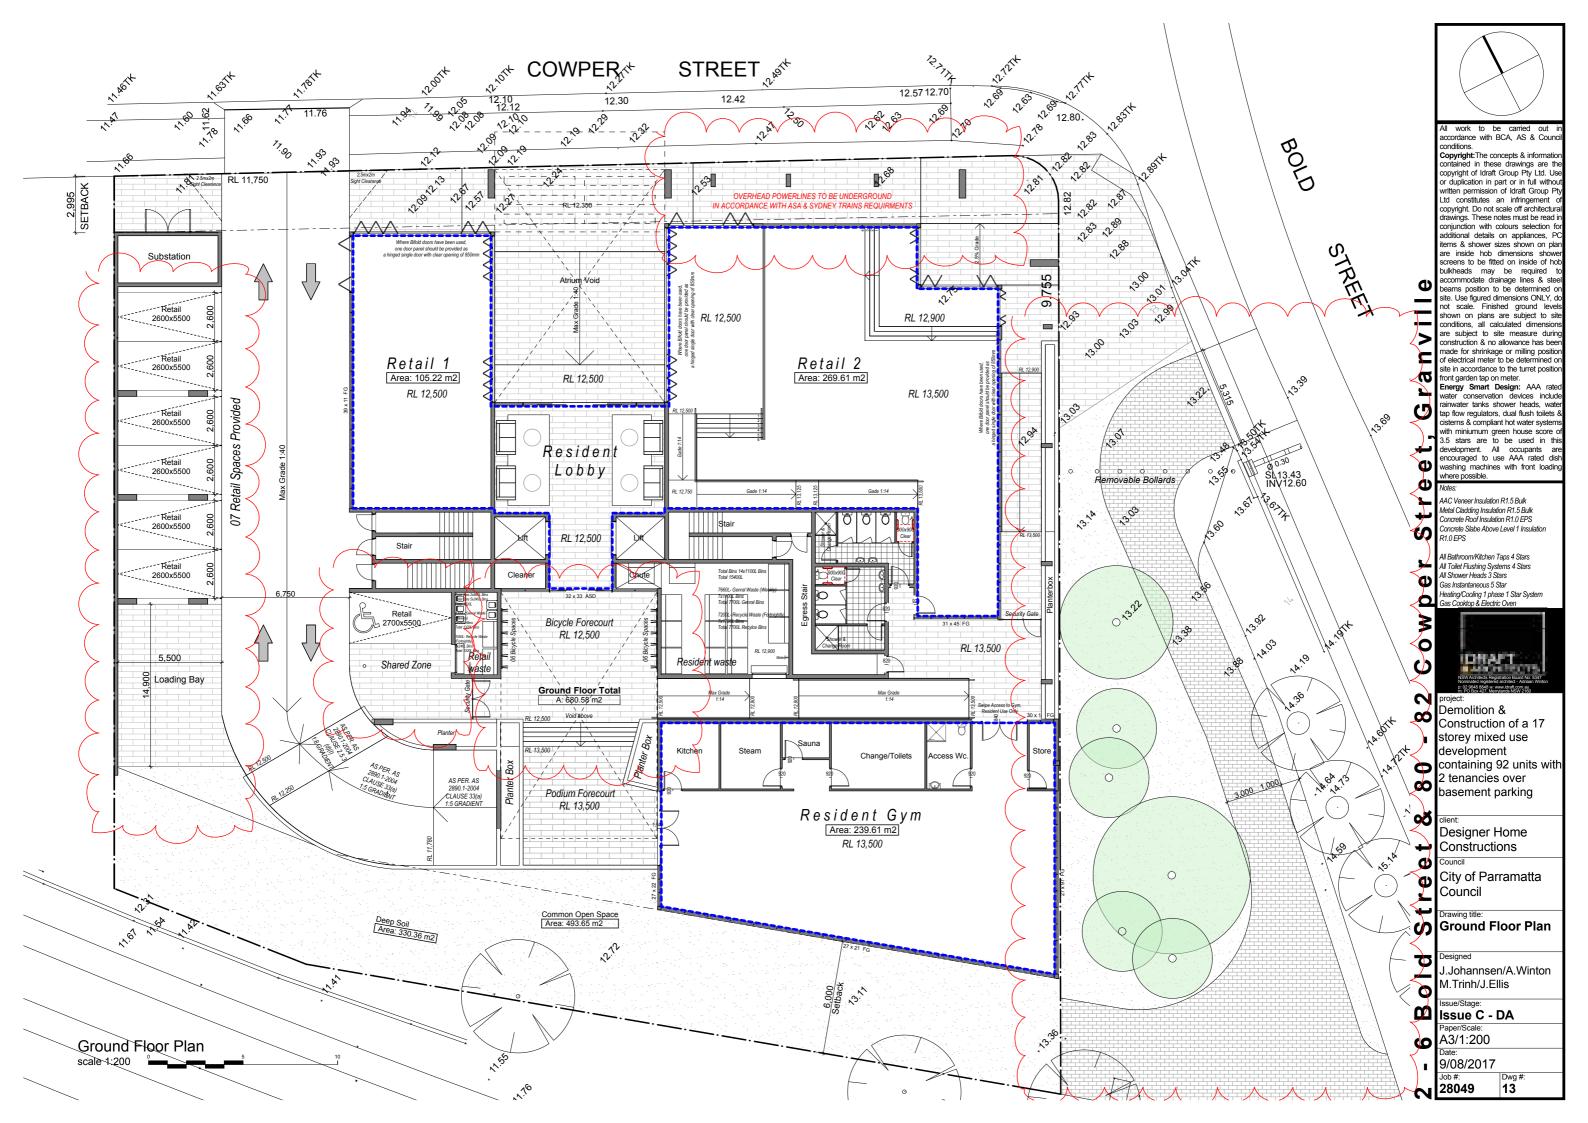


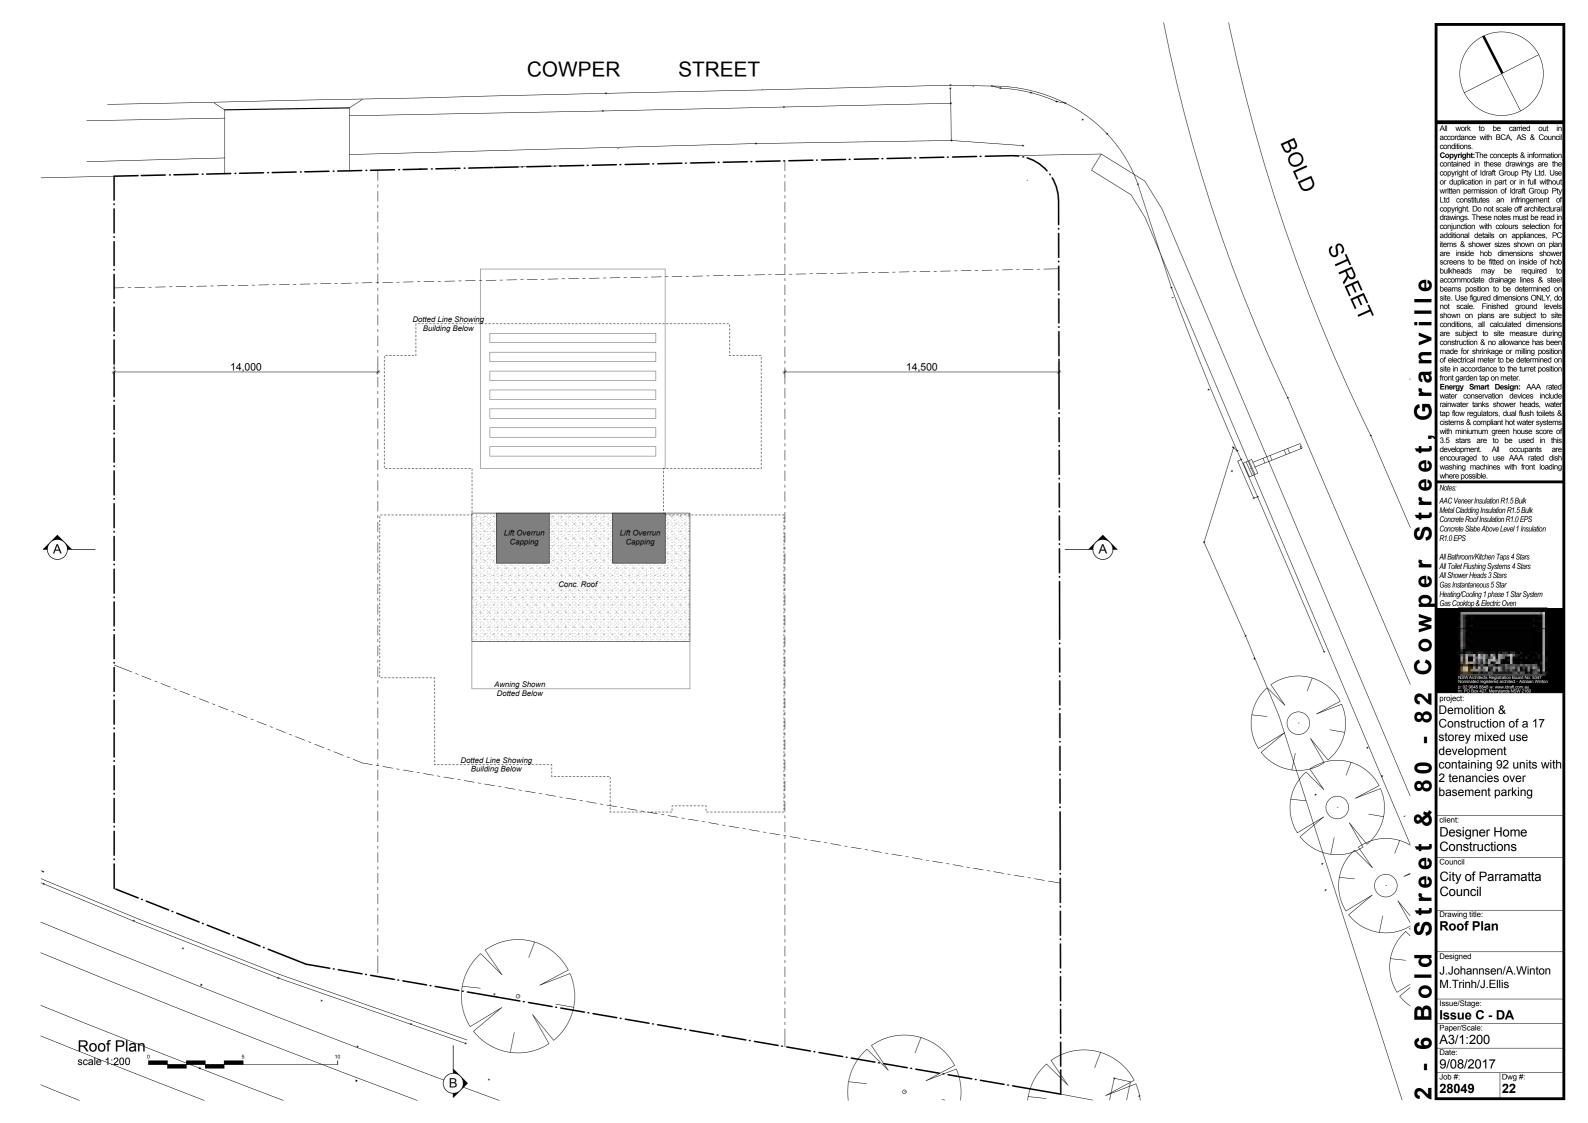





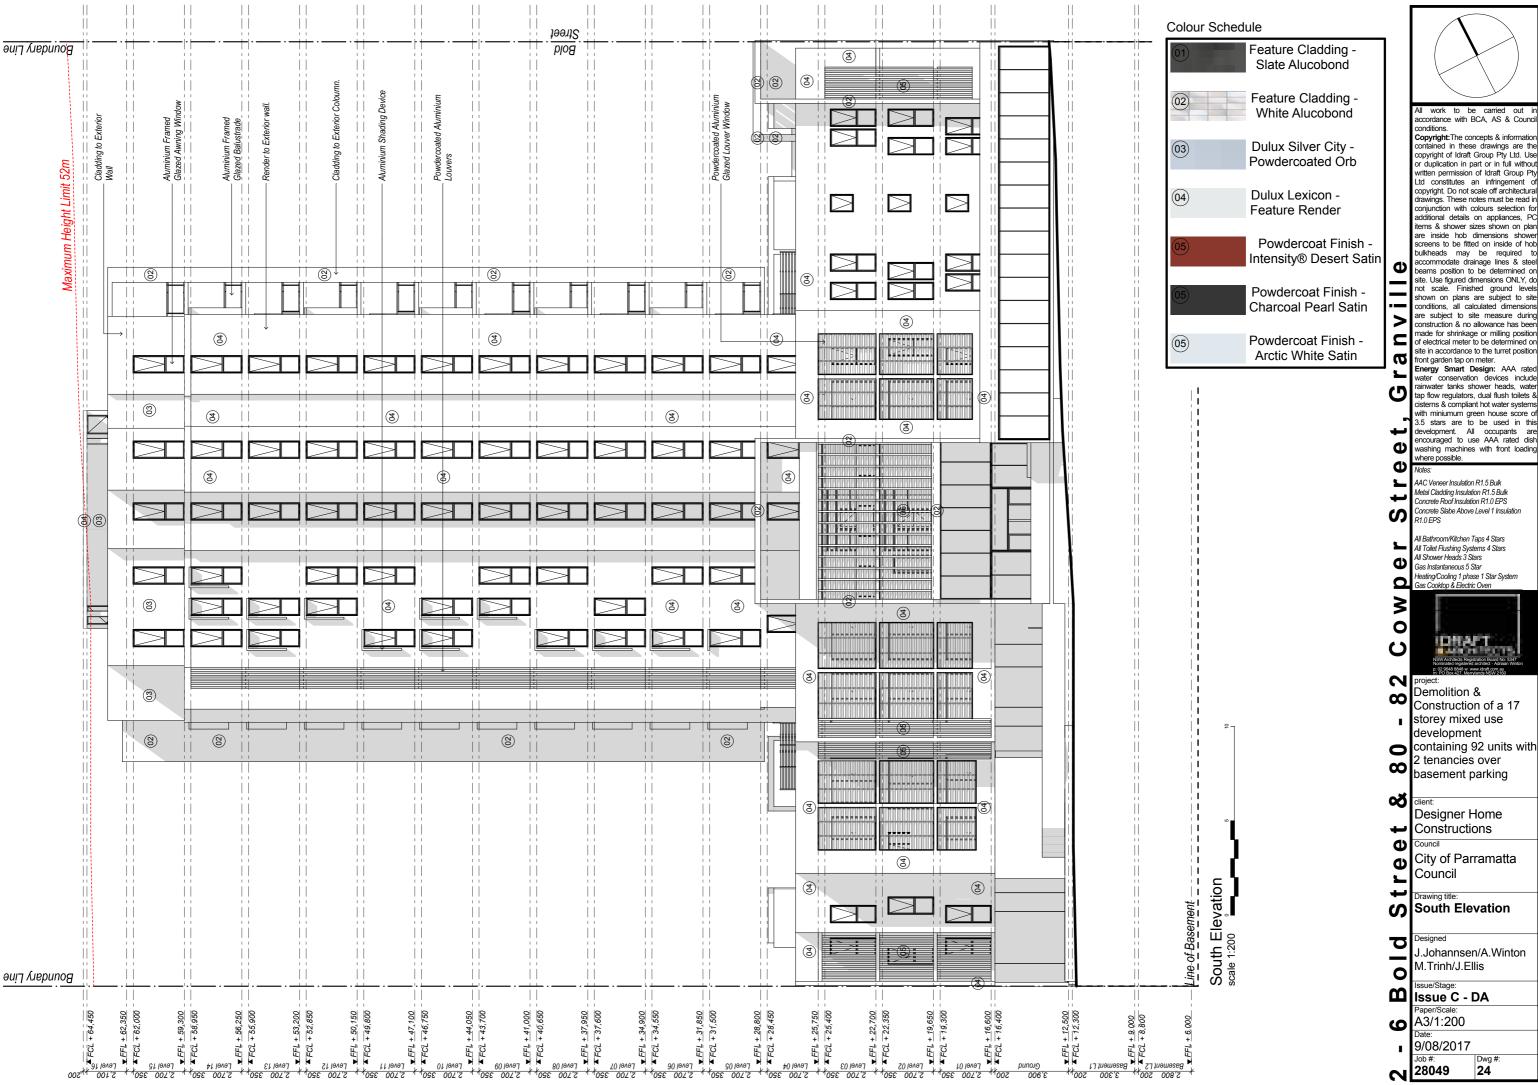

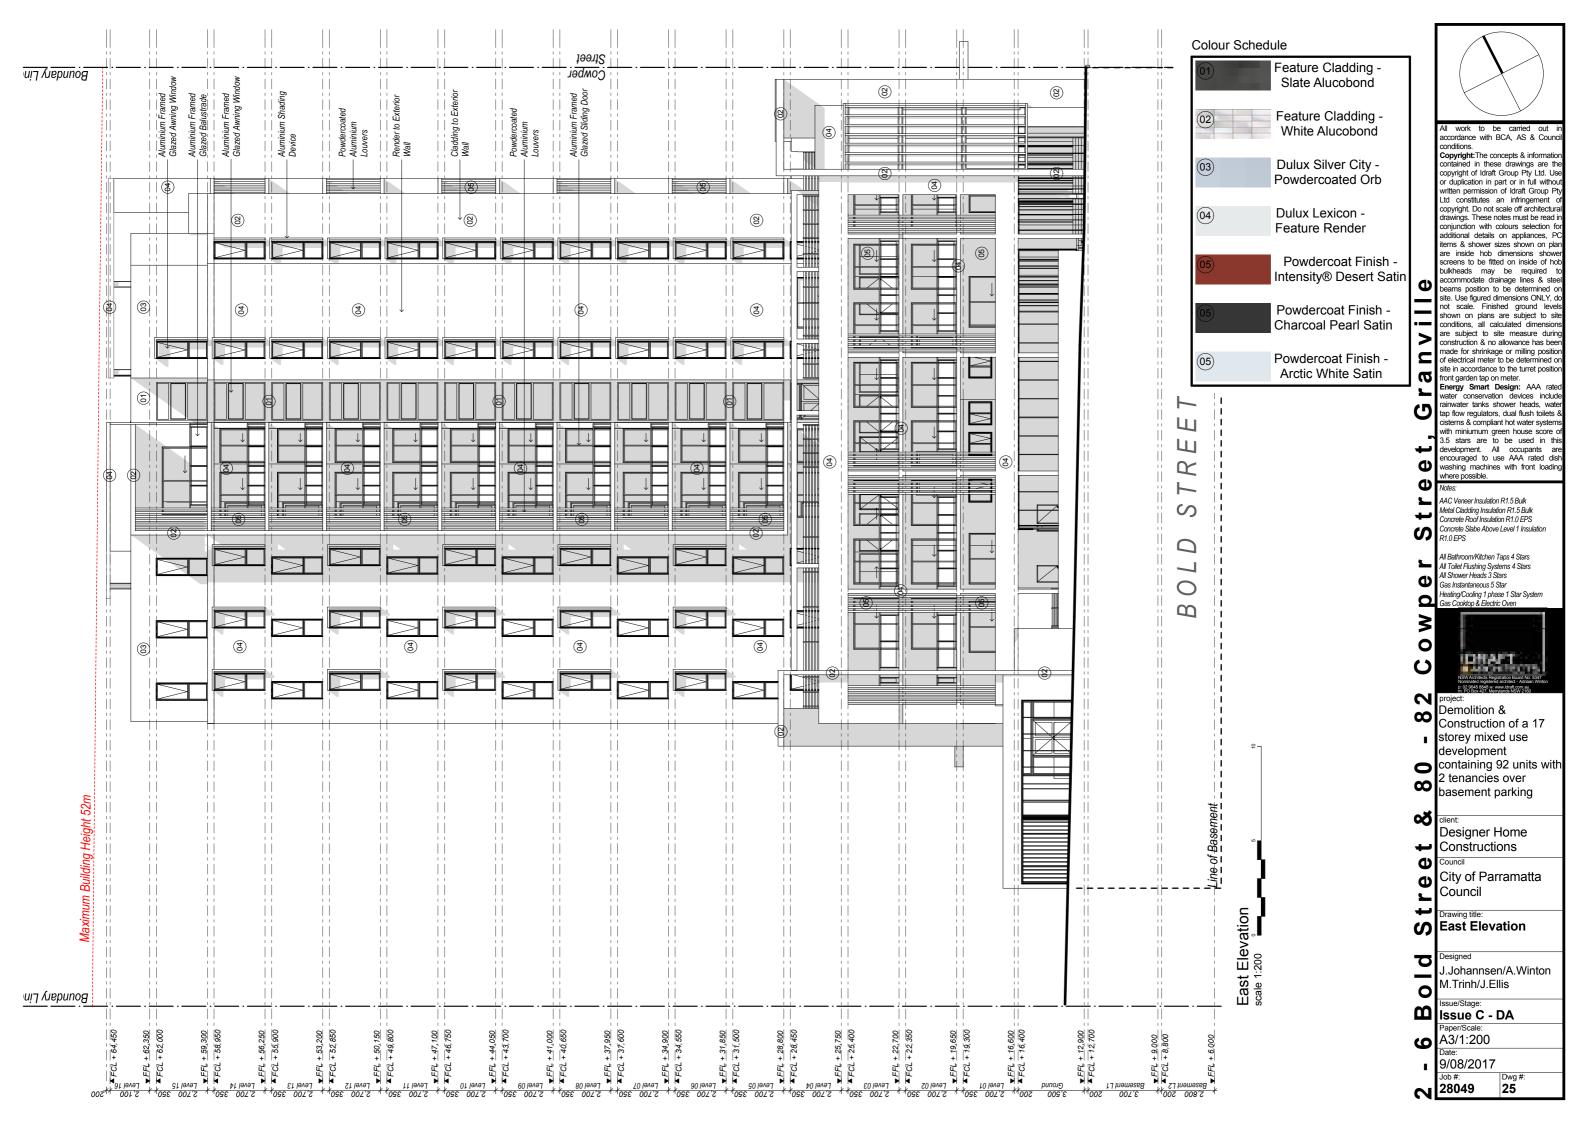

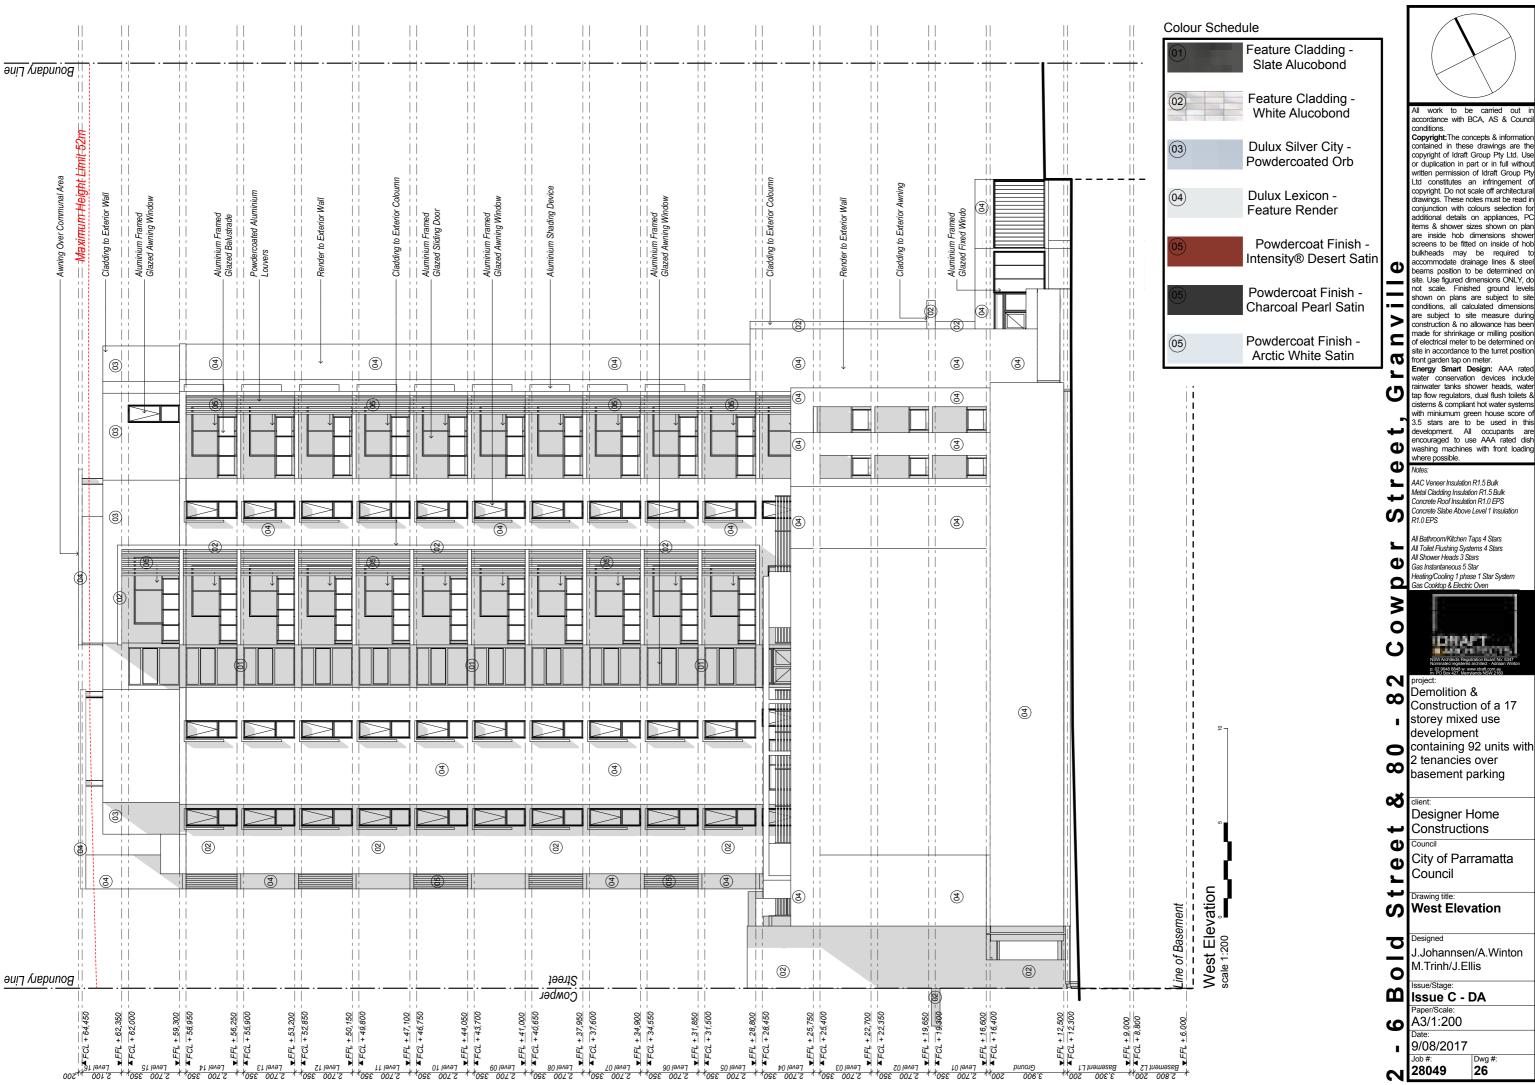

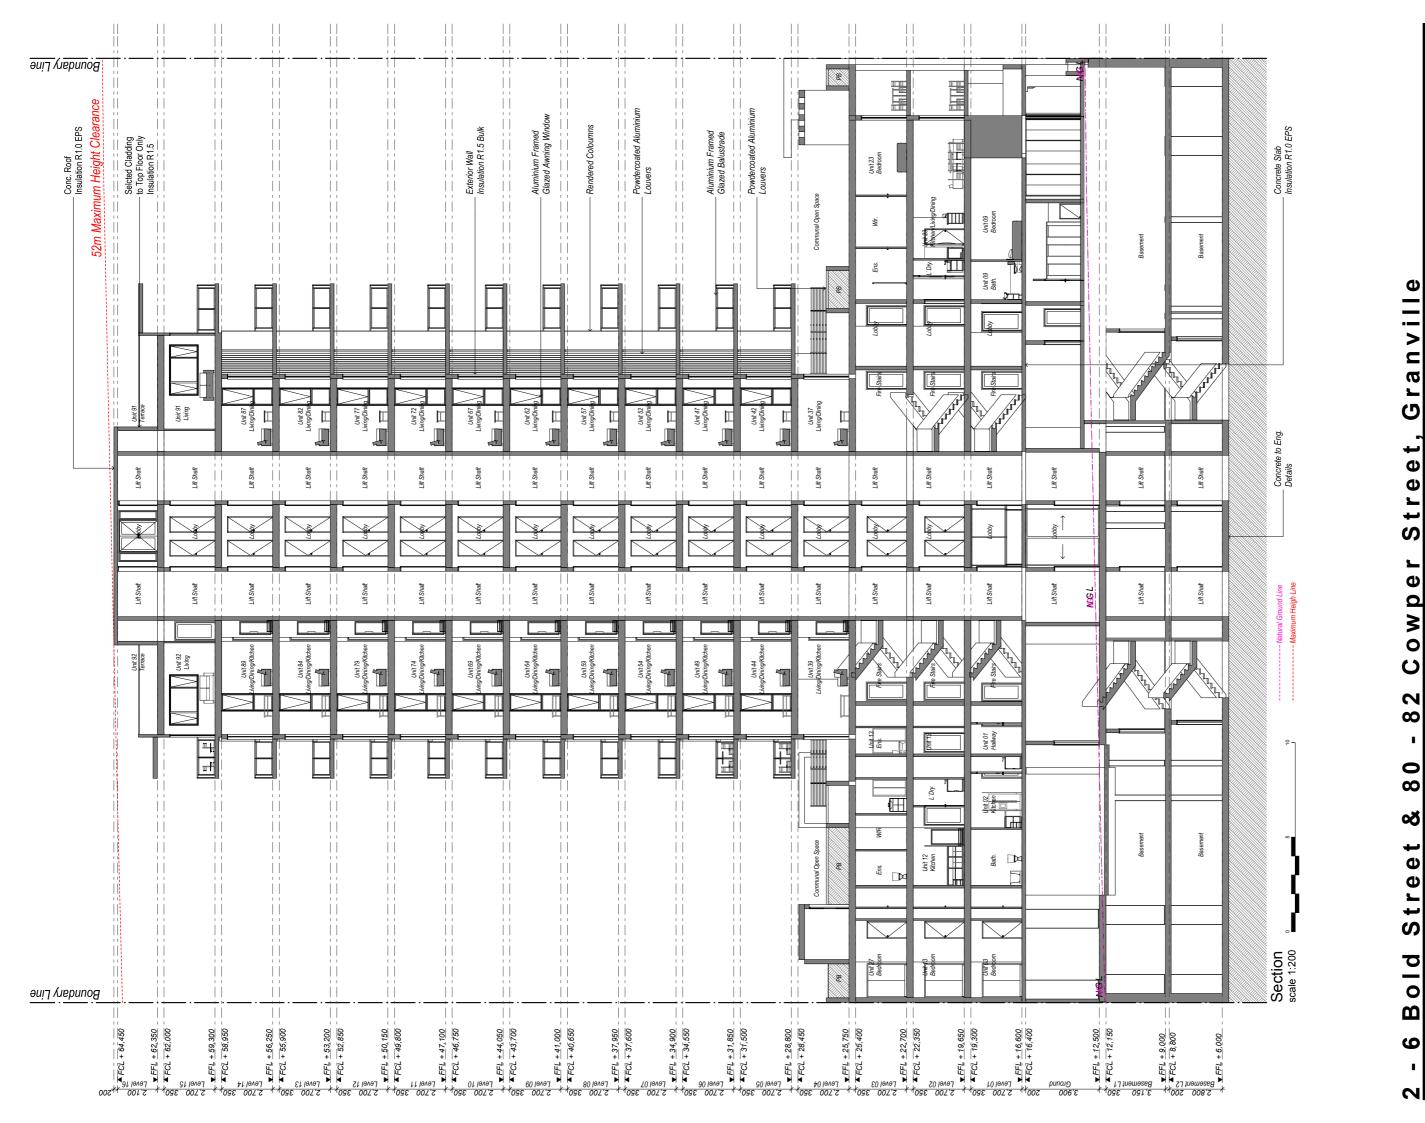

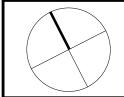

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front garden tap on meter.

Energy Smart Design: AAA rated water conservation devices include rainwater tanks shower heads, water tap flow regulators, dual flush toilets tap now regulators, dual flush tollets & cisterns & compliant hot water systems with miniumum green house score of 3.5 stars are to be used in this development. All occupants are encouraged to use AAA rated dish washing machines with front load where possible.

_ AAC Veneer Insulation R1.5 Bulk Metal Cladding Insulation R1.5 Bulk Concrete Roof Insulation R1.0 EPS
Concrete Slabe Above Level 1 Insulation R1.0 EPS

All Bathroom/Kitchen Taps 4 Stars All Toilet Flushing Systems 4 Stars All Shower Heads 3 Stars Φ Gas Instantaneous 5 Star

Heating/Cooling 1 phase 1 Star System Gas Cooktop & Electric Oven



Demolition & Construction of a 17 storey mixed use development containing 92 units with 2 tenancies over basement parking

> Designer Home Constructions


City of Parramatta Council


Section A-A

J.Johannsen/A.Winton M.Trinh/J.Ellis 0

Issue C - DA A3/1:200

9/08/2017 Dwg # 28049

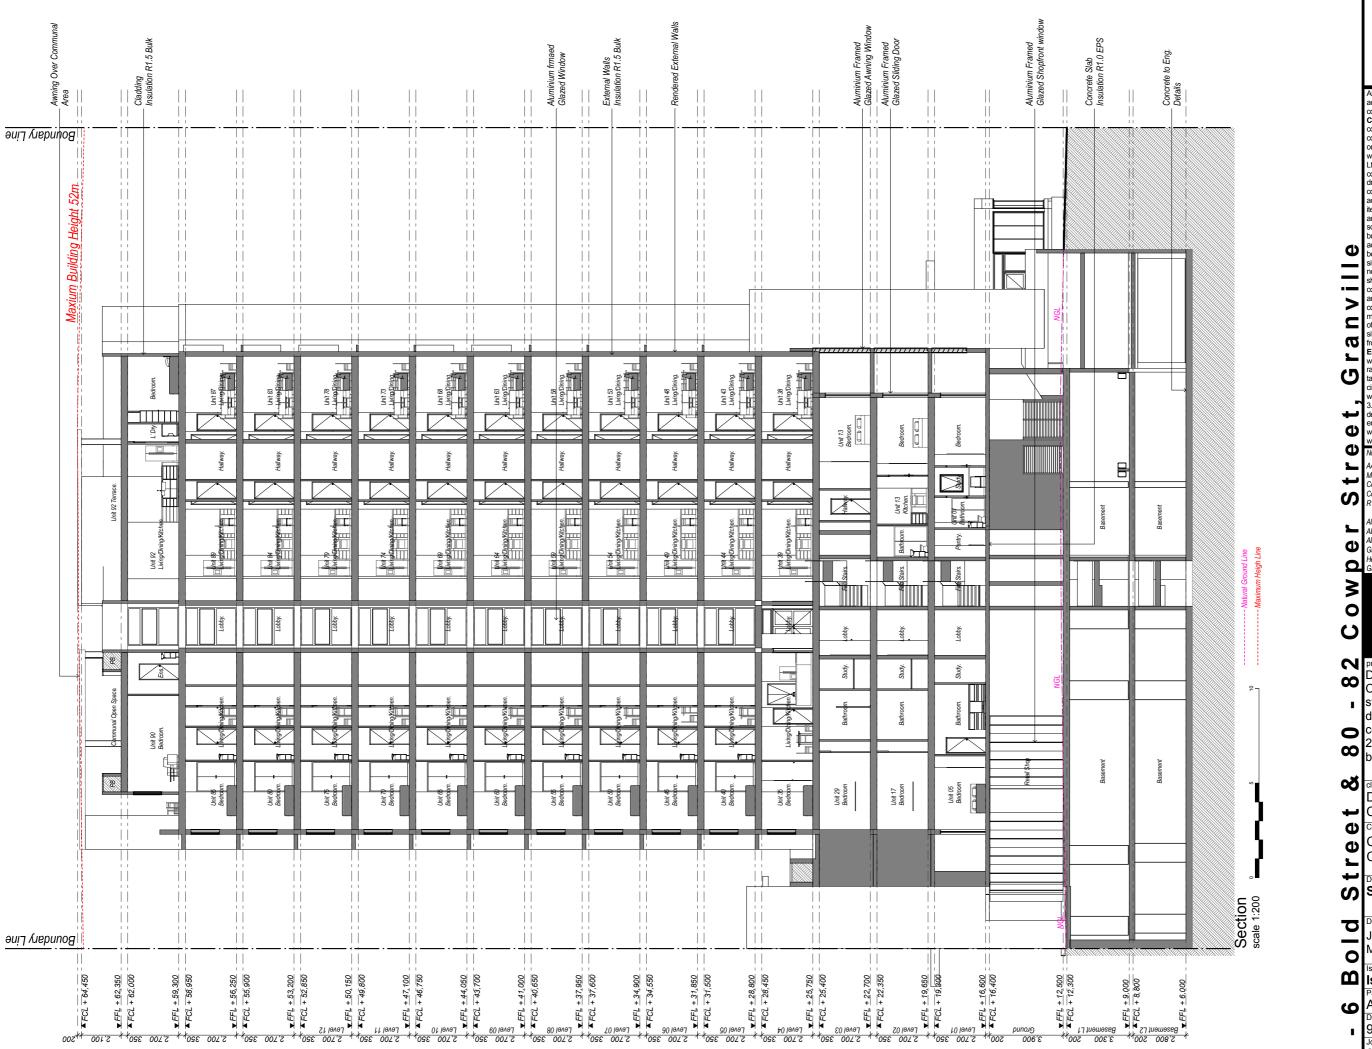

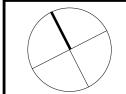

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Energy Smart Design: AAA rate

water conservation devices include ainwater tanks shower heads, wate tap flow regulators, dual flush toilets cisterns & compliant hot water system with miniumum green house score 3.5 stars are to be used in this development. All occupants are encouraged to use AAA rated dish washing machines with front loadi where possible.

AAC Veneer Insulation R1.5 Bulk Metal Cladding Insulation R1.5 Bulk Concrete Roof Insulation R1.0 EPS
Concrete Slabe Above Level 1 Insulation R10FPS

All Bathroom/Kitchen Taps 4 Stars All Toilet Flushing Systems 4 Stars All Shower Heads 3 Stars Gas Instantaneous 5 Star

Heating/Cooling 1 phase 1 Star System Gas Cooktop & Electric Oven



Demolition & Construction of a 17 storey mixed use development containing 92 units with 2 tenancies over basement parking

> Designer Home Constructions

City of Parramatta Council


(7) Section B-B


J.Johannsen/A.Winton M.Trinh/J.Ellis

Issue C - DA

9/08/2017 28049 28

A3/1:200

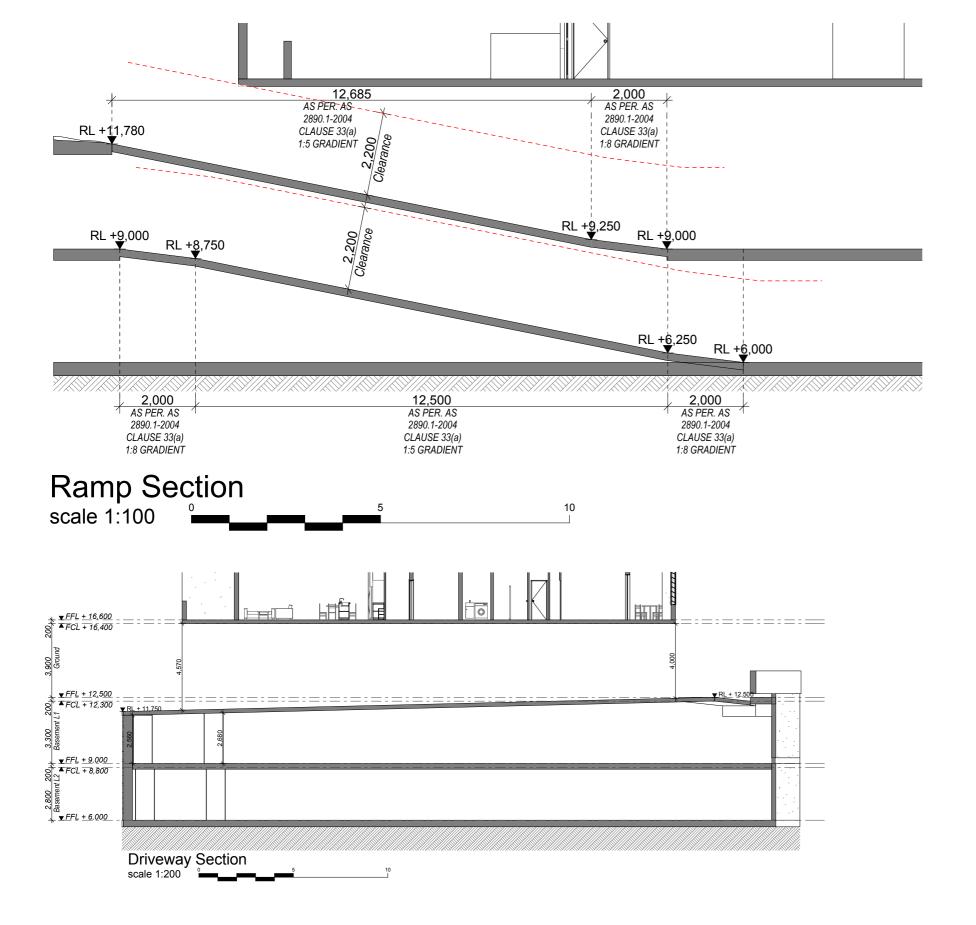

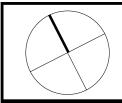

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Energy Smart Design: AAA rated water conservation devices include rainwater tanks shower heads, water tap flow regulators, dual flush toliets & cistems & compliant hot water systems with minilumum green house score of 3.5 stars are to be used in this development. All occupants are encouraged to use AAA rated dish washing machines with front loading G washing machines with front load where possible. Φ

AAC Veneer Insulation R1.5 Bulk Metal Cladding Insulation R1.5 Bulk Concrete Roof Insulation R1.0 EPS Concrete Slabe Above Level 1 Insulation R10FPS

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All Bathroom/Kitchen Taps 4 Stars All Toilet Flushing Systems 4 Stars All Shower Heads 3 Stars Gas Instantaneous 5 Star Heating/Cooling 1 phase 1 Star System Gas Cooktop & Electric Oven Q

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Demolition & ∞ Construction of a 17 storey mixed use development containing 92 units with 2 tenancies over basement parking

∞ Designer Home Constructions

Council

City of Parramatta Φ Council


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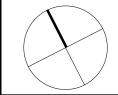
7 J.Johannsen/A.Winton M.Trinh/J.Ellis 0

Issue C - DA

A3/1:100, 1:200

9/08/2017 Dwg # **№** 28049



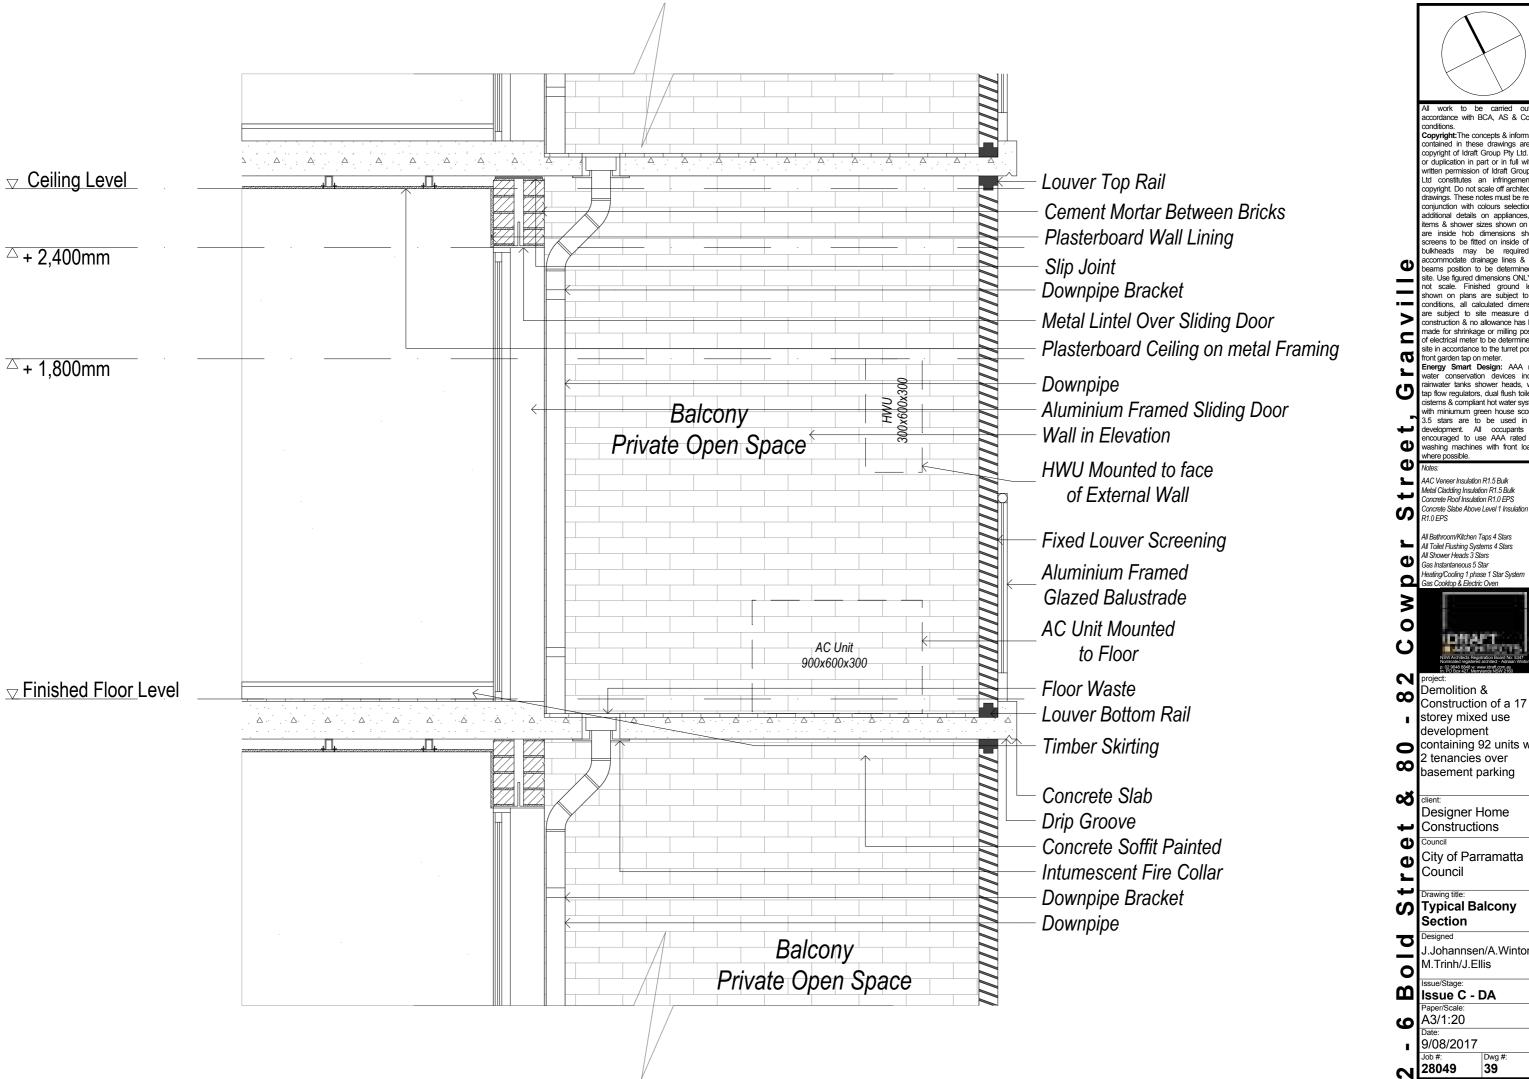

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AAC Veneer Insulation R1.5 Bulk Metal Cladding Insulation R1.5 Bulk Concrete Roof Insulation R1.0 EPS Concrete Slabe Above Level 1 Insulation

All Bathroom/Kitchen Taps 4 Stars All Toilet Flushing Systems 4 Stars All Shower Heads 3 Stars

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Demolition & Construction of a 17 storey mixed use development

containing 92 units with 2 tenancies over basement parking

> Designer Home Constructions

City of Parramatta


Typical Balcony Section


J.Johannsen/A.Winton


M.Trinh/J.Ellis

9/08/2017


Dwg :

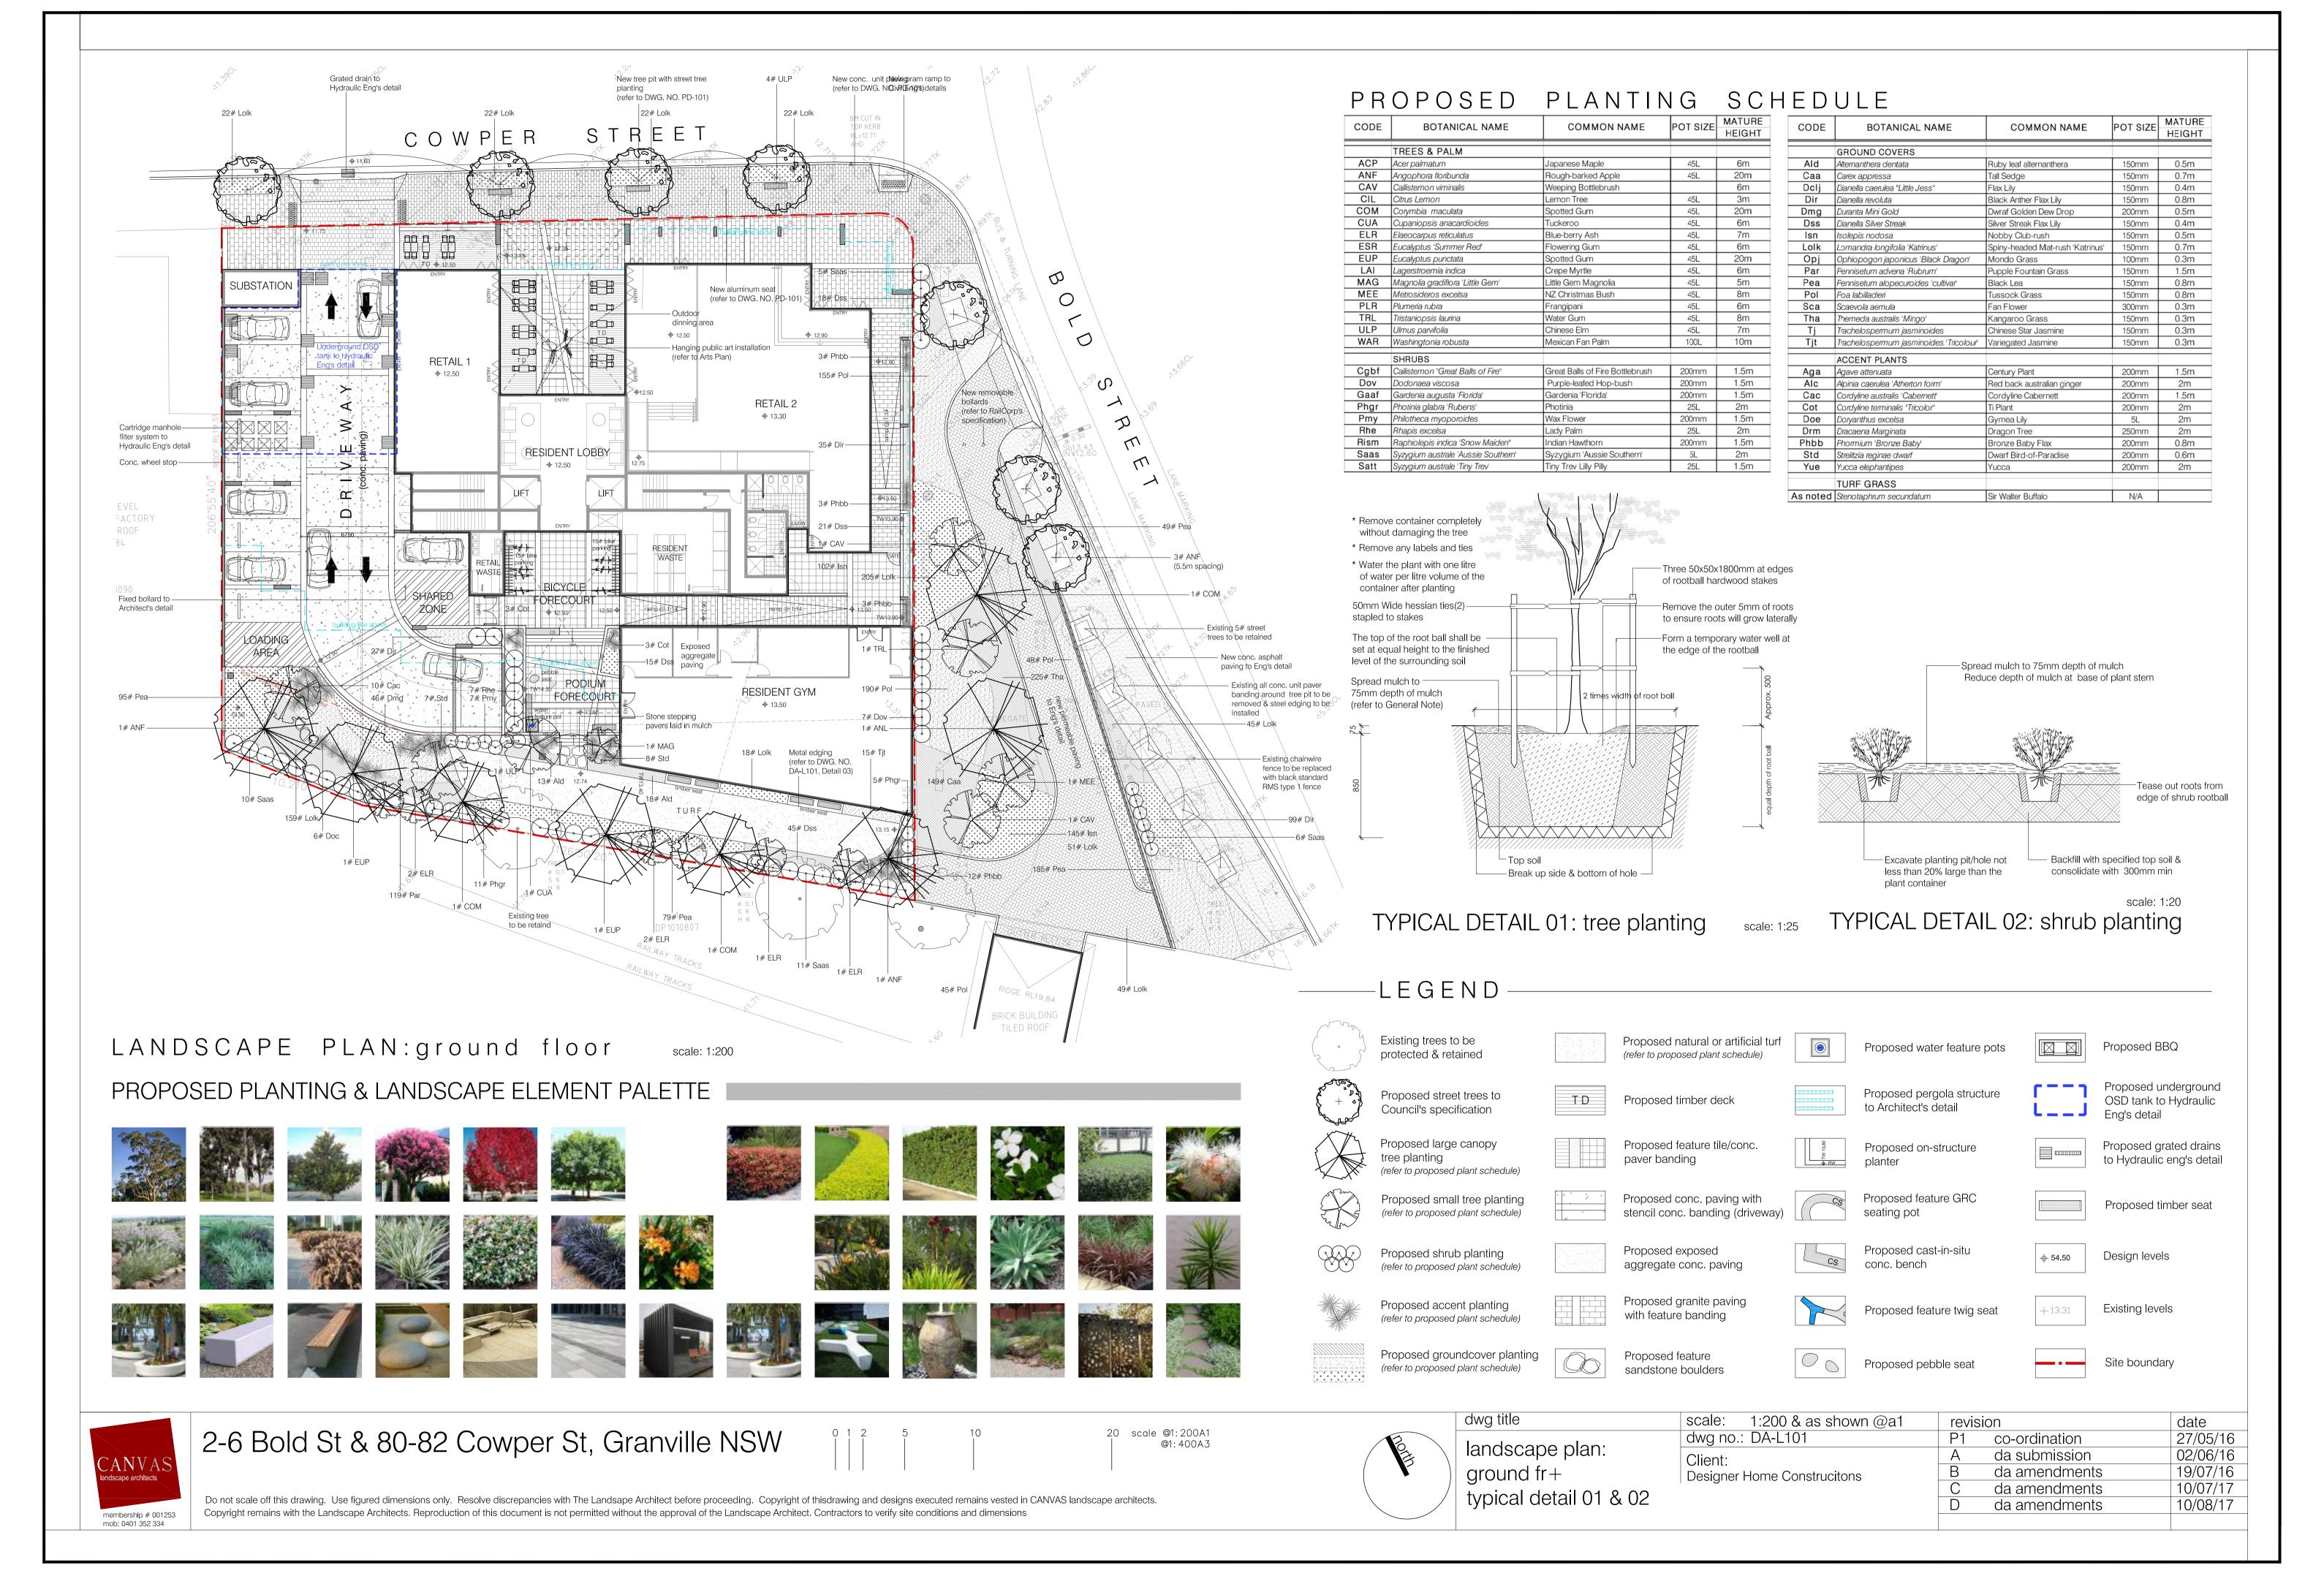

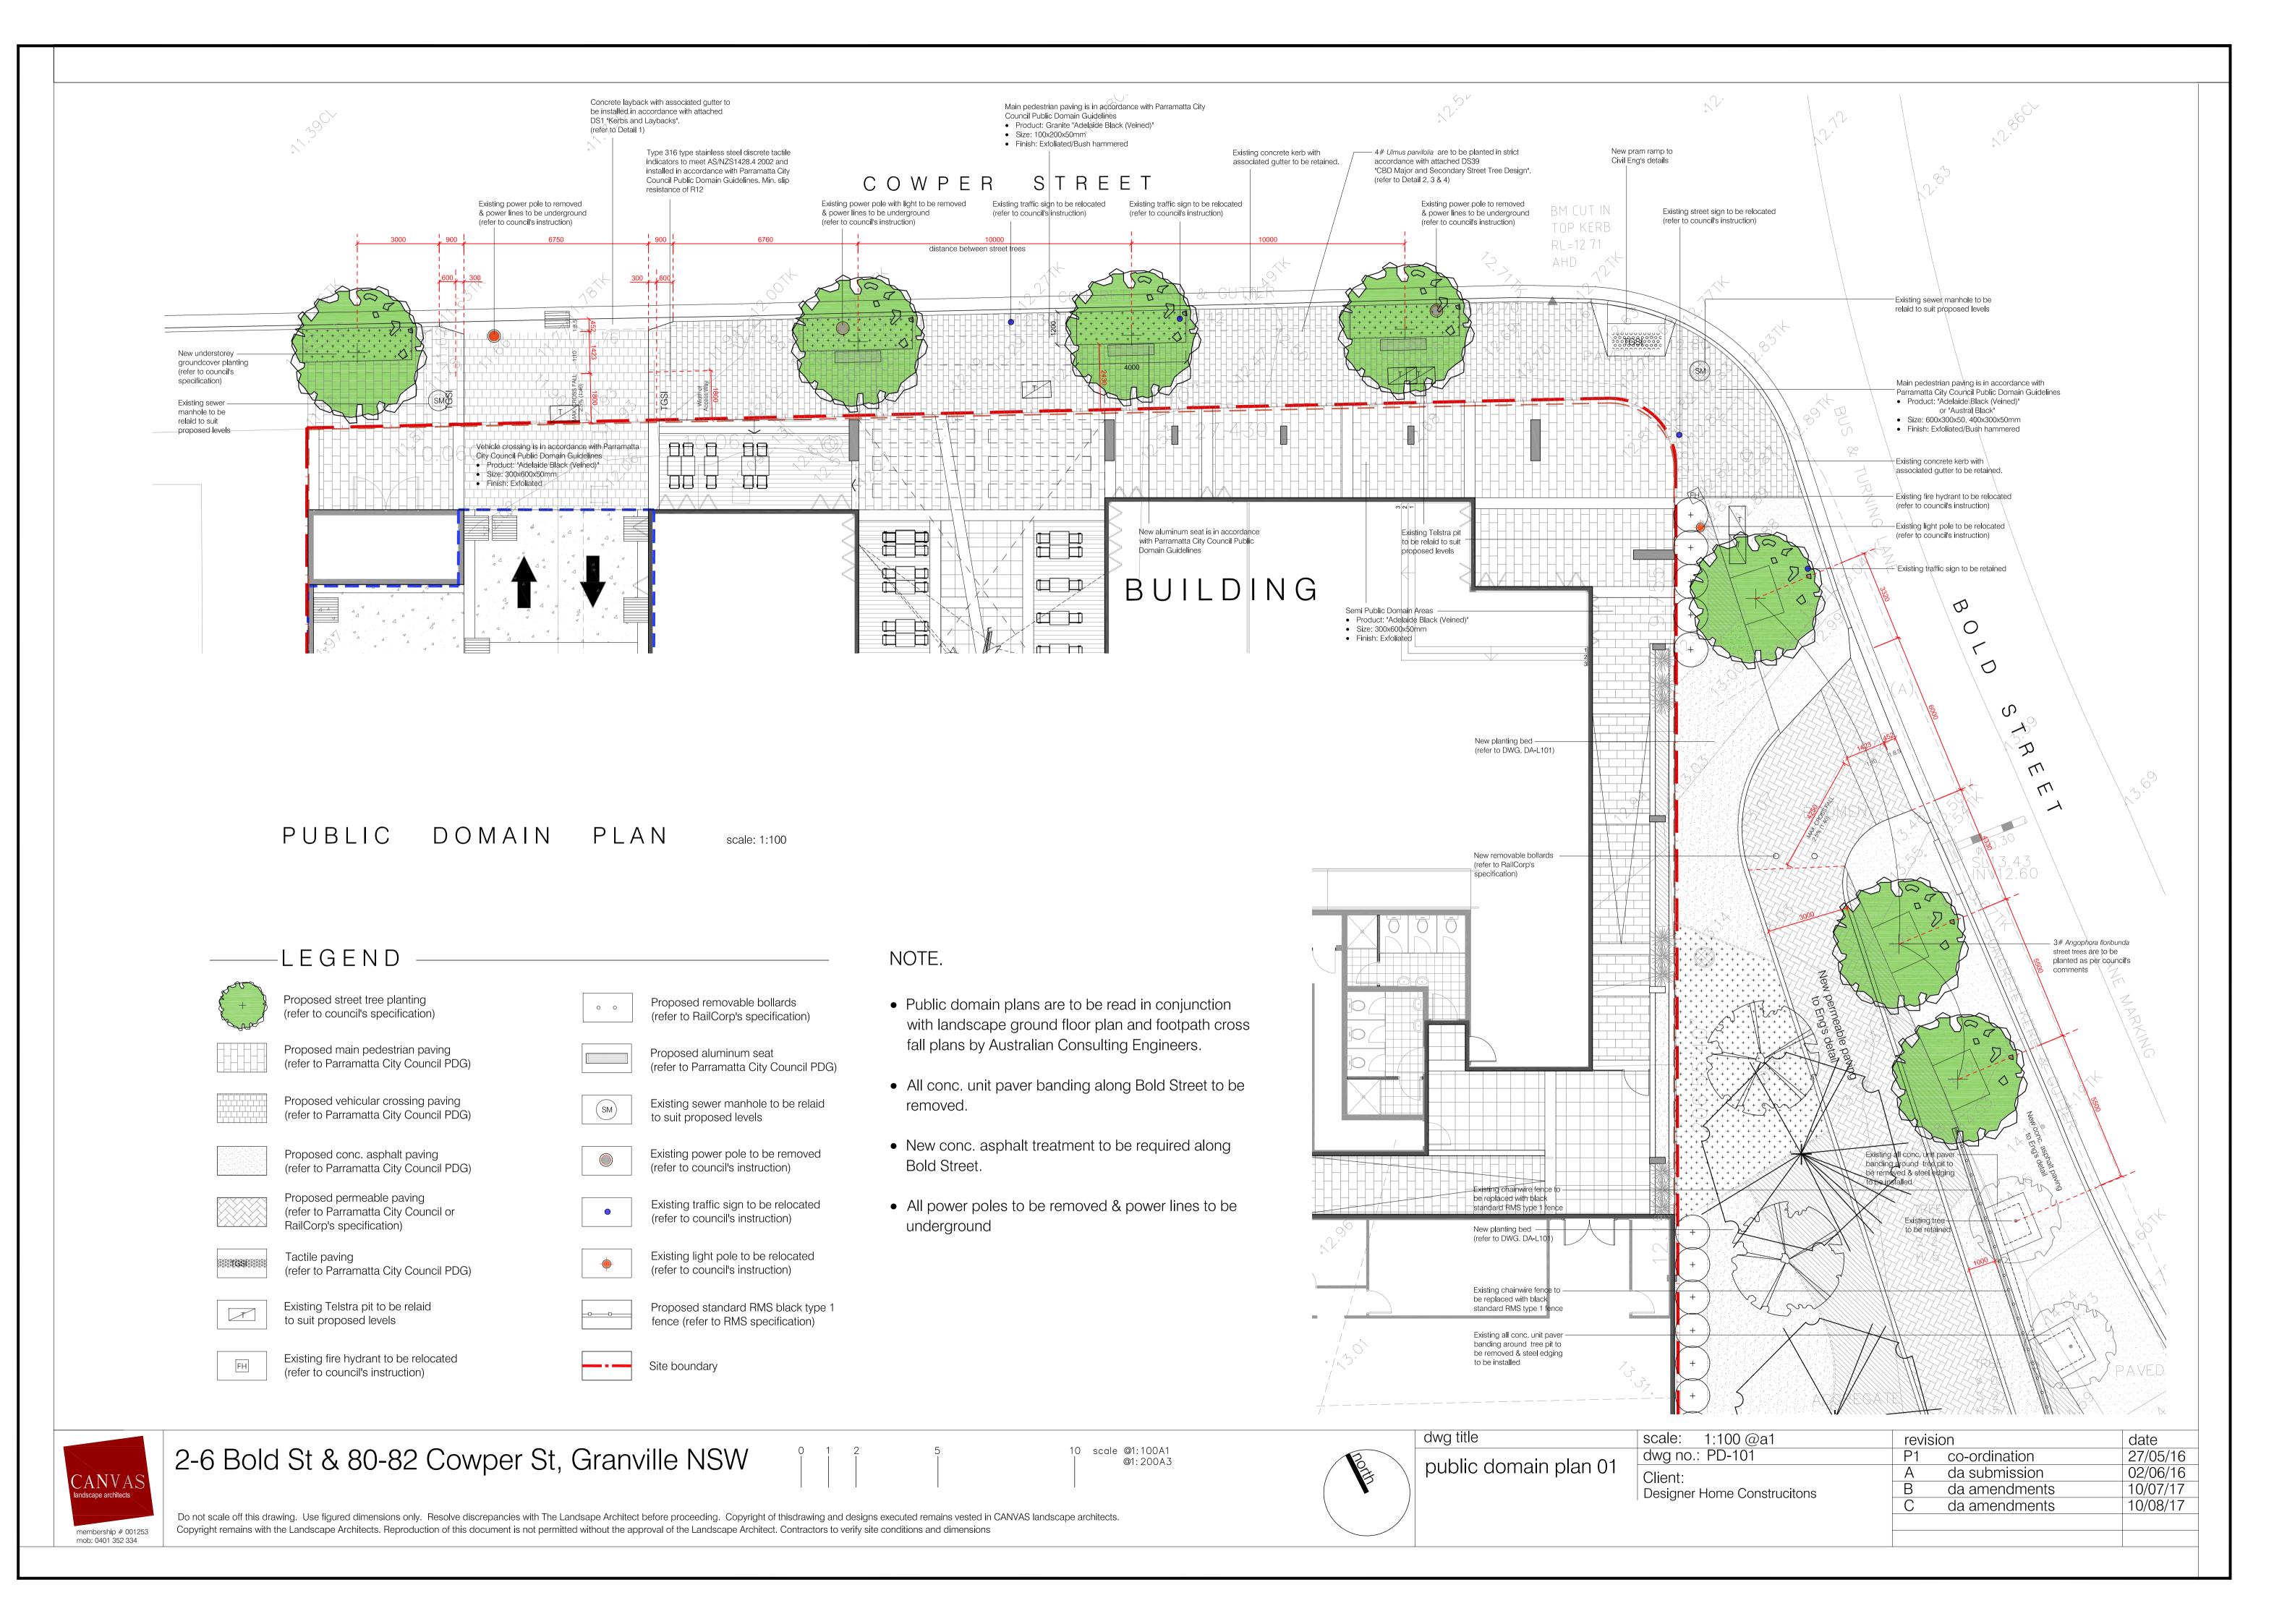

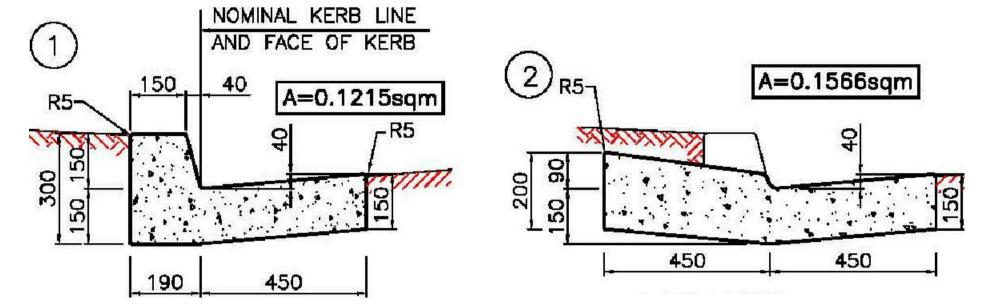

DETAIL 1: kerb & gutter + layback scale: 1:10

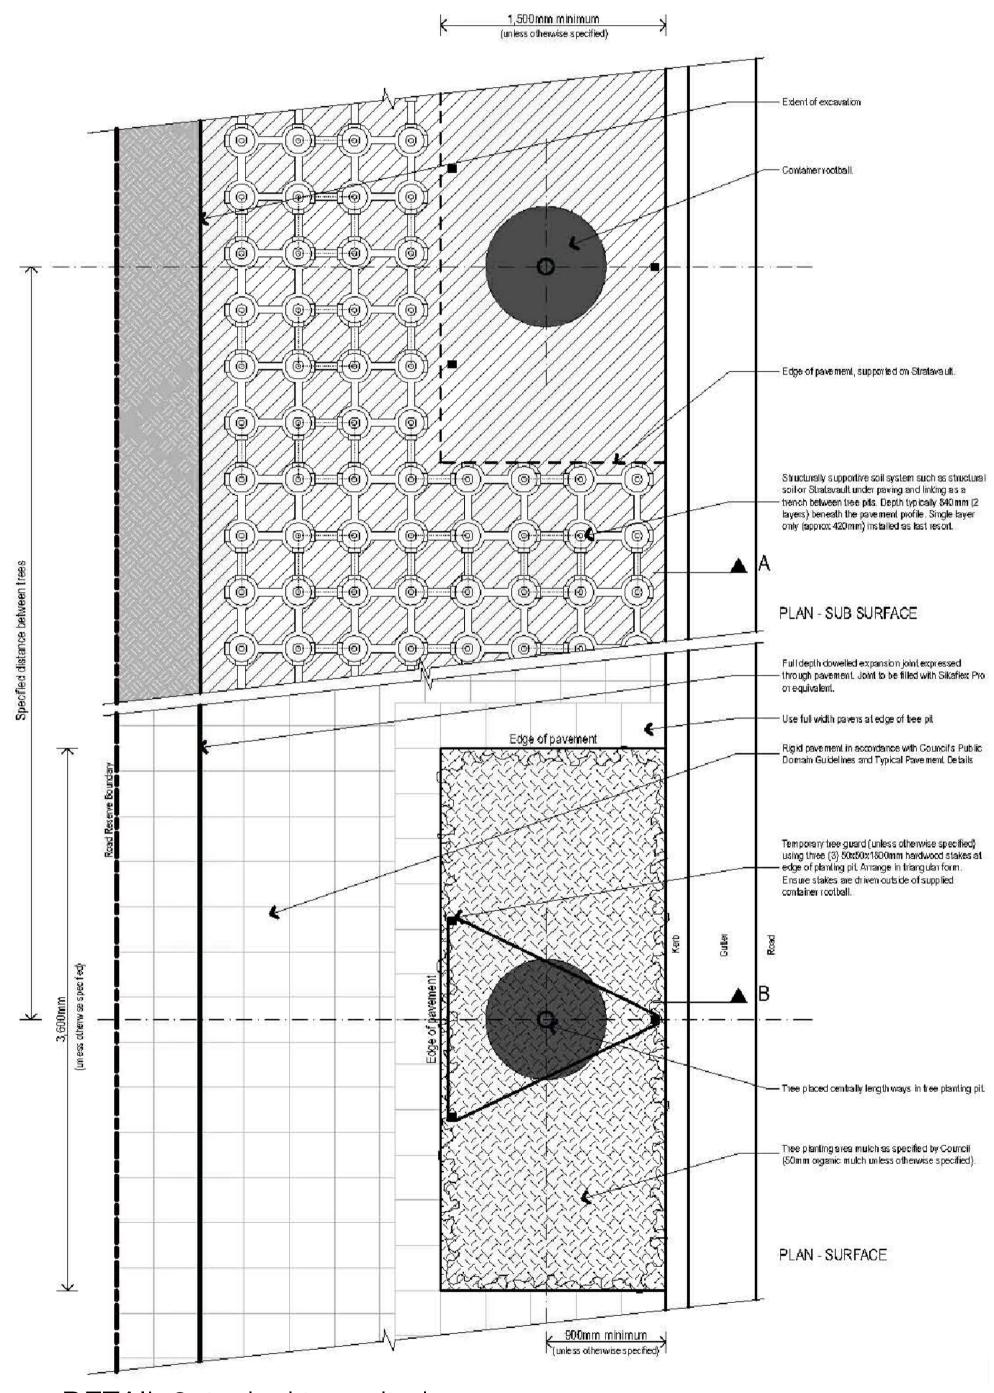

DETAIL 2: typical tree pit plan

CANVAS landscape architects

membership # 001253 mob: 0401 352 334


2-6 Bold St & 80-82 Cowper St, Granville NSW

Do not scale off this drawing. Use figured dimensions only. Resolve discrepancies with The Landsape Architect before proceeding. Copyright of thisdrawing and designs executed remains vested in CANVAS landscape architects. Copyright remains with the Landscape Architects. Reproduction of this document is not permitted without the approval of the Landscape Architect. Contractors to verify site conditions and dimensions


NOTE.

Four inspections will be required during construction.

- 1. Inspection of sub-grade prior to pouring of concrete blinding layer.
- 2. Inspection of finished concrete prior to placement of pavers.
- 3. Inspection of paving after placement.
- 4. Final inspection of paving (including seal).

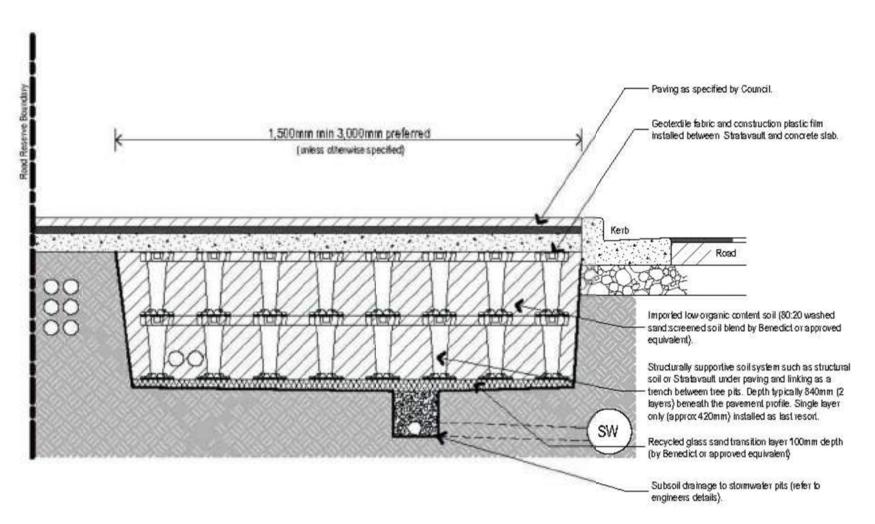


DETAIL 3: typical section of structural soil

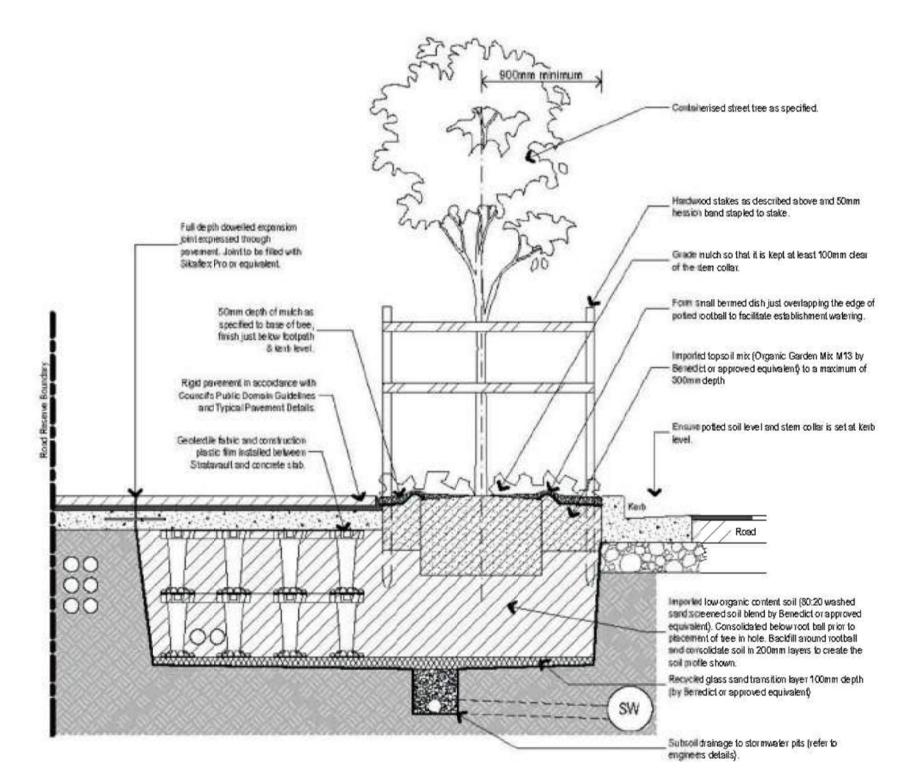



DETAIL 4: typical section of planting area

scale: 1:	25
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dwg title	scale: 1:10 & 25 @a1	revisi	on	date
public domain plan 02:	dwg no.: PD-102	P1	co-ordination	27/05/16
	Client:	Α	da submission	02/06/16
typical details	Designer Home Construcitons	В	da amendments	10/07/17
	1 2 3 1 g	С	da amendments	10/08/17




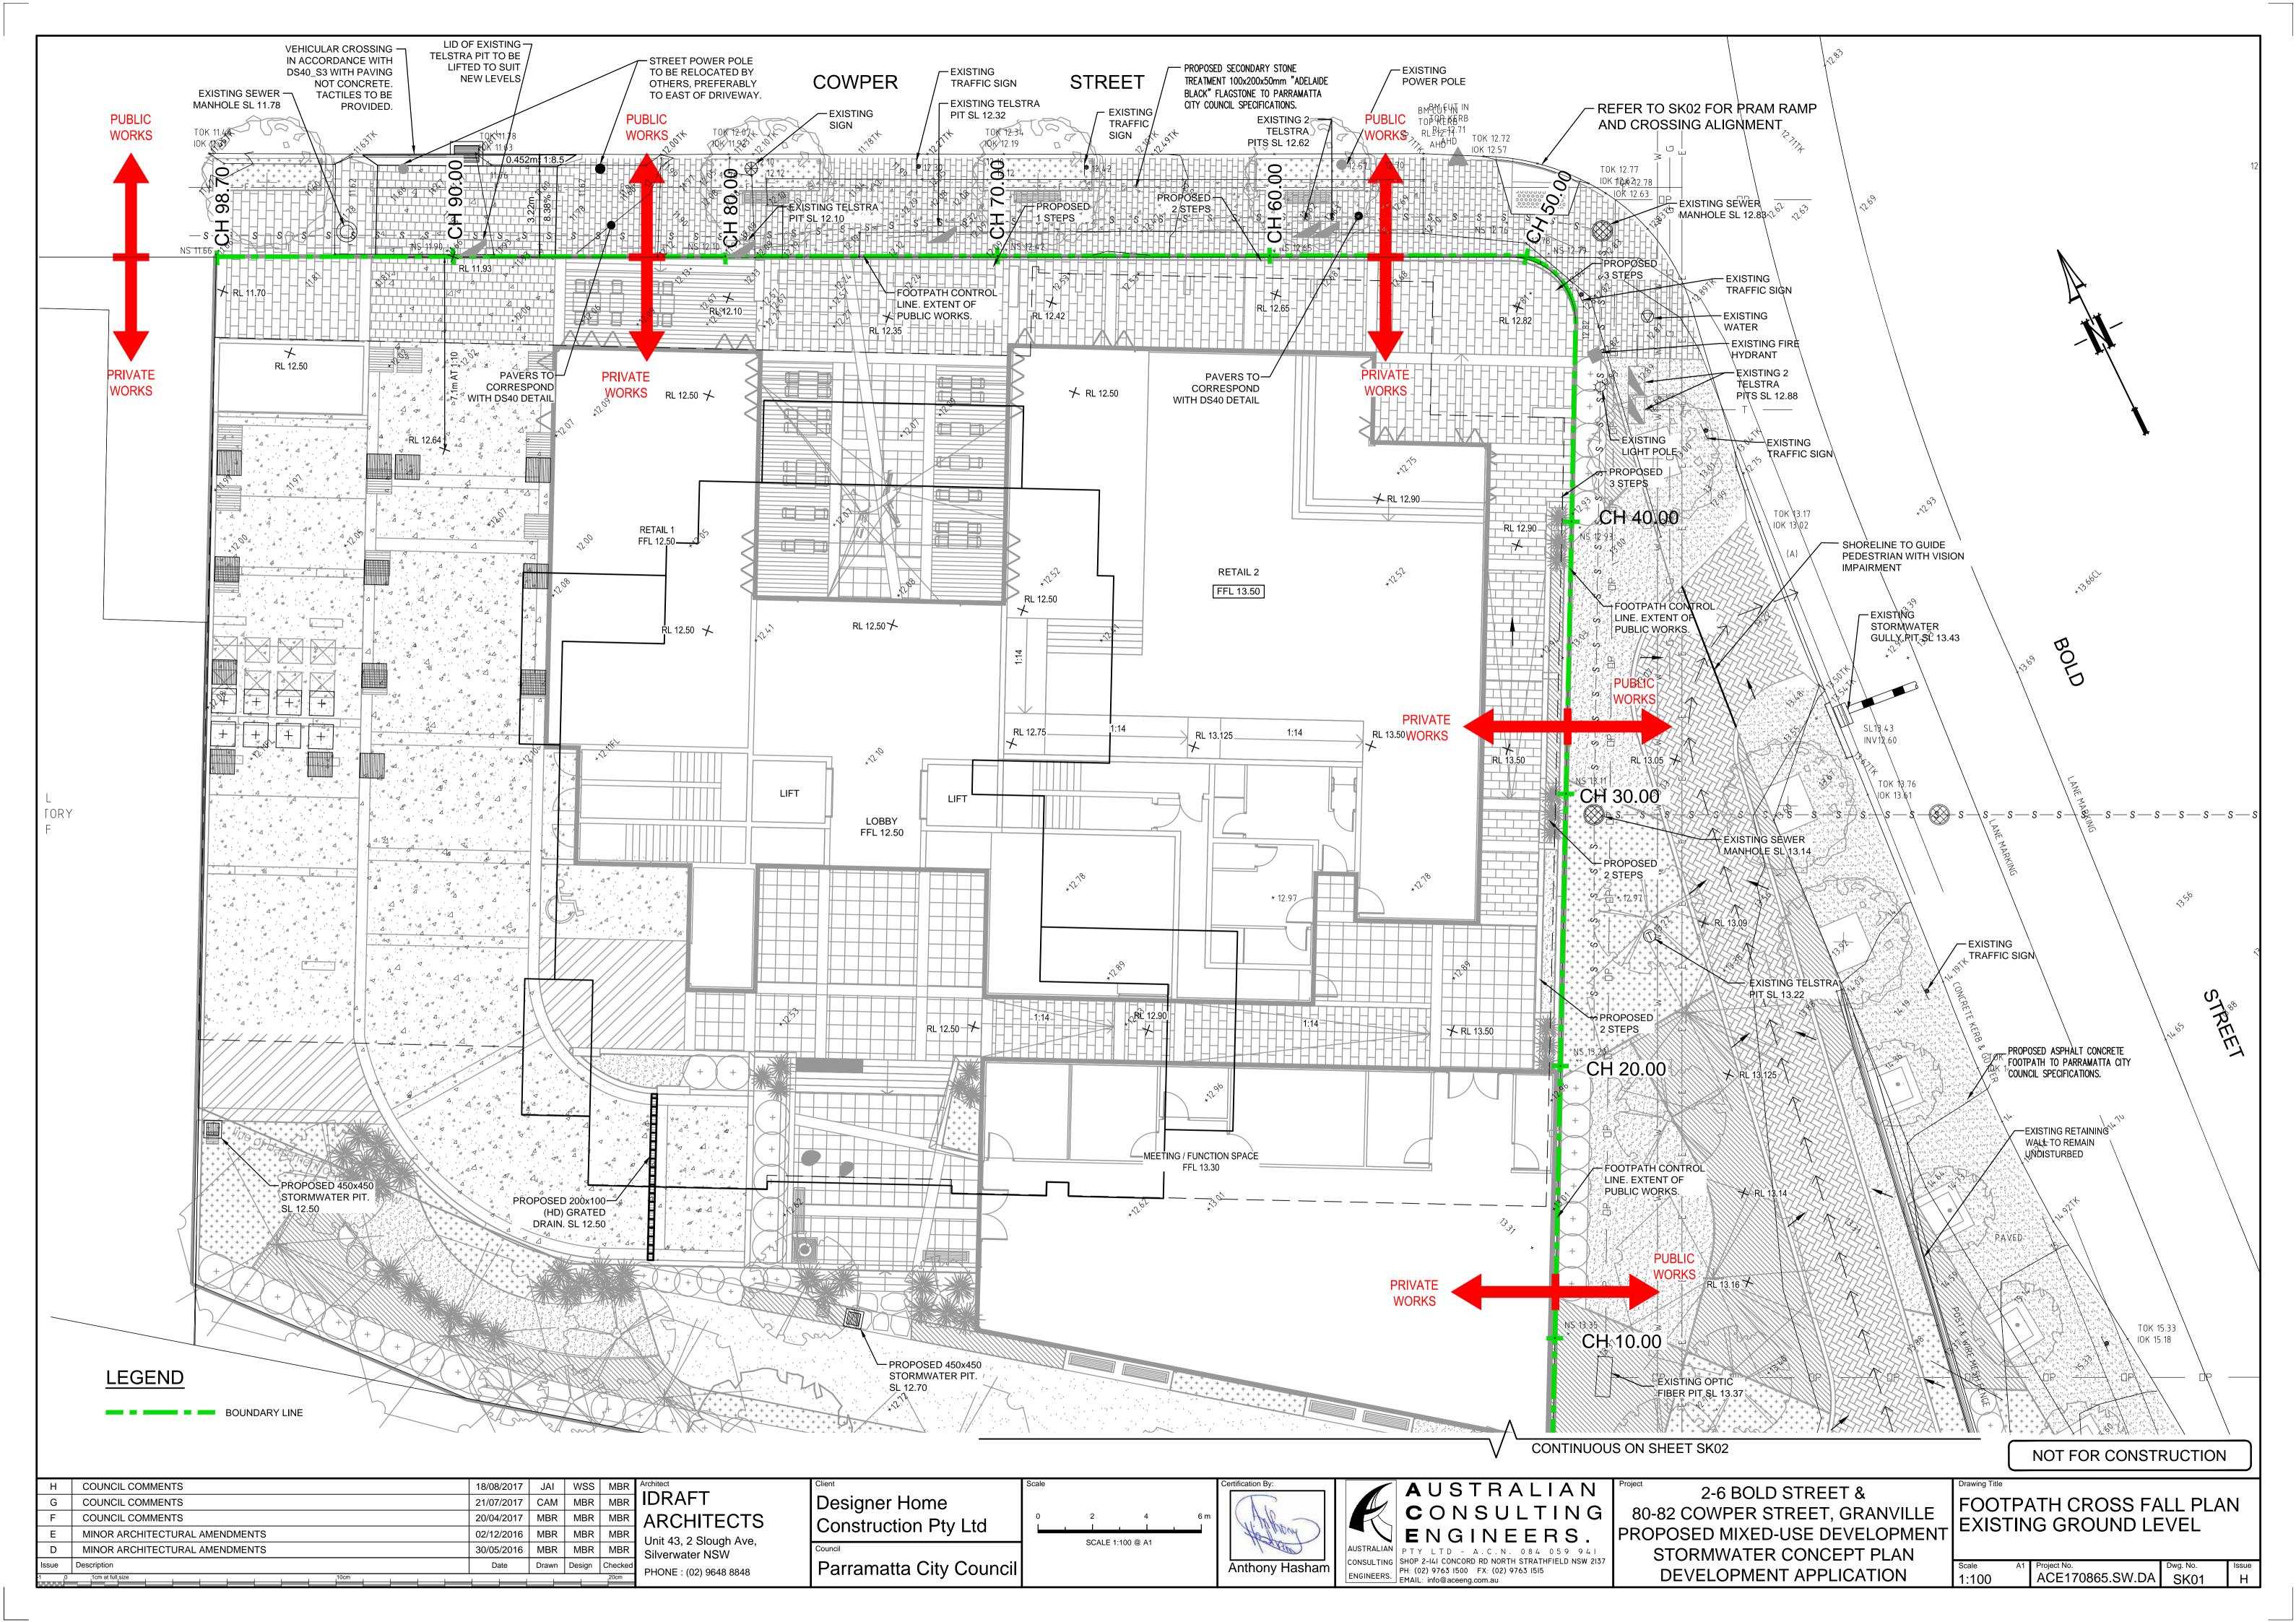

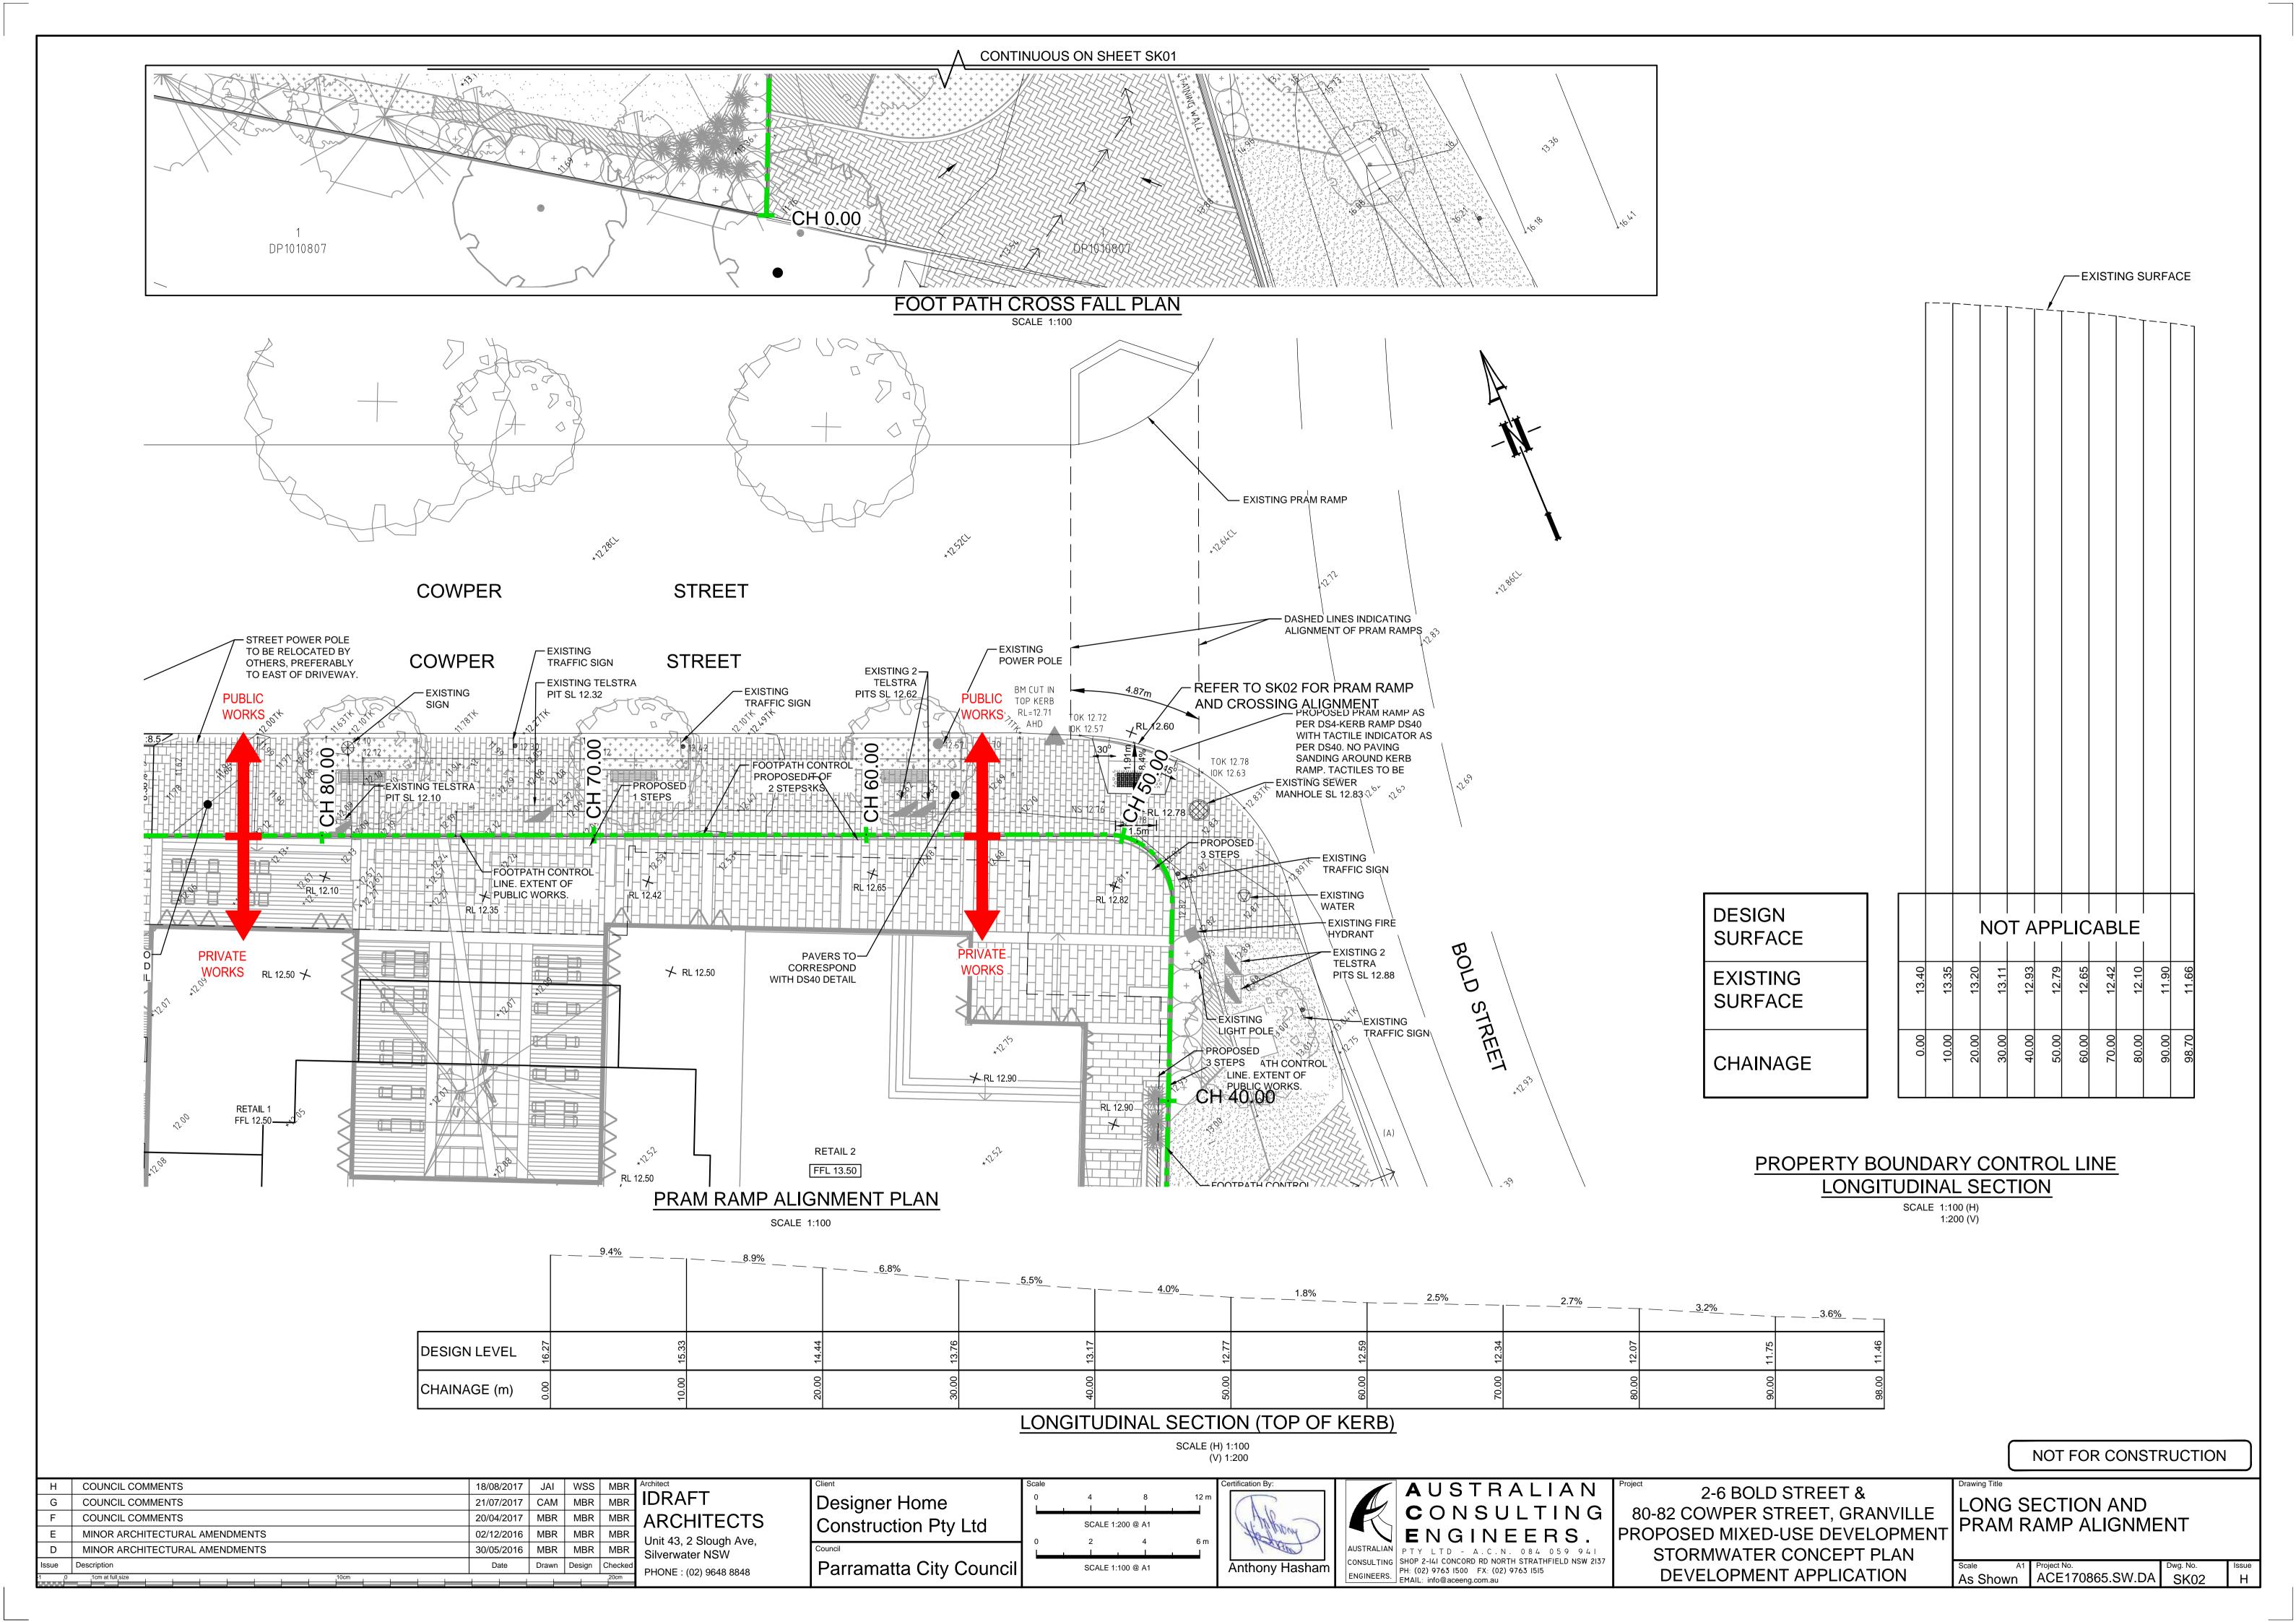

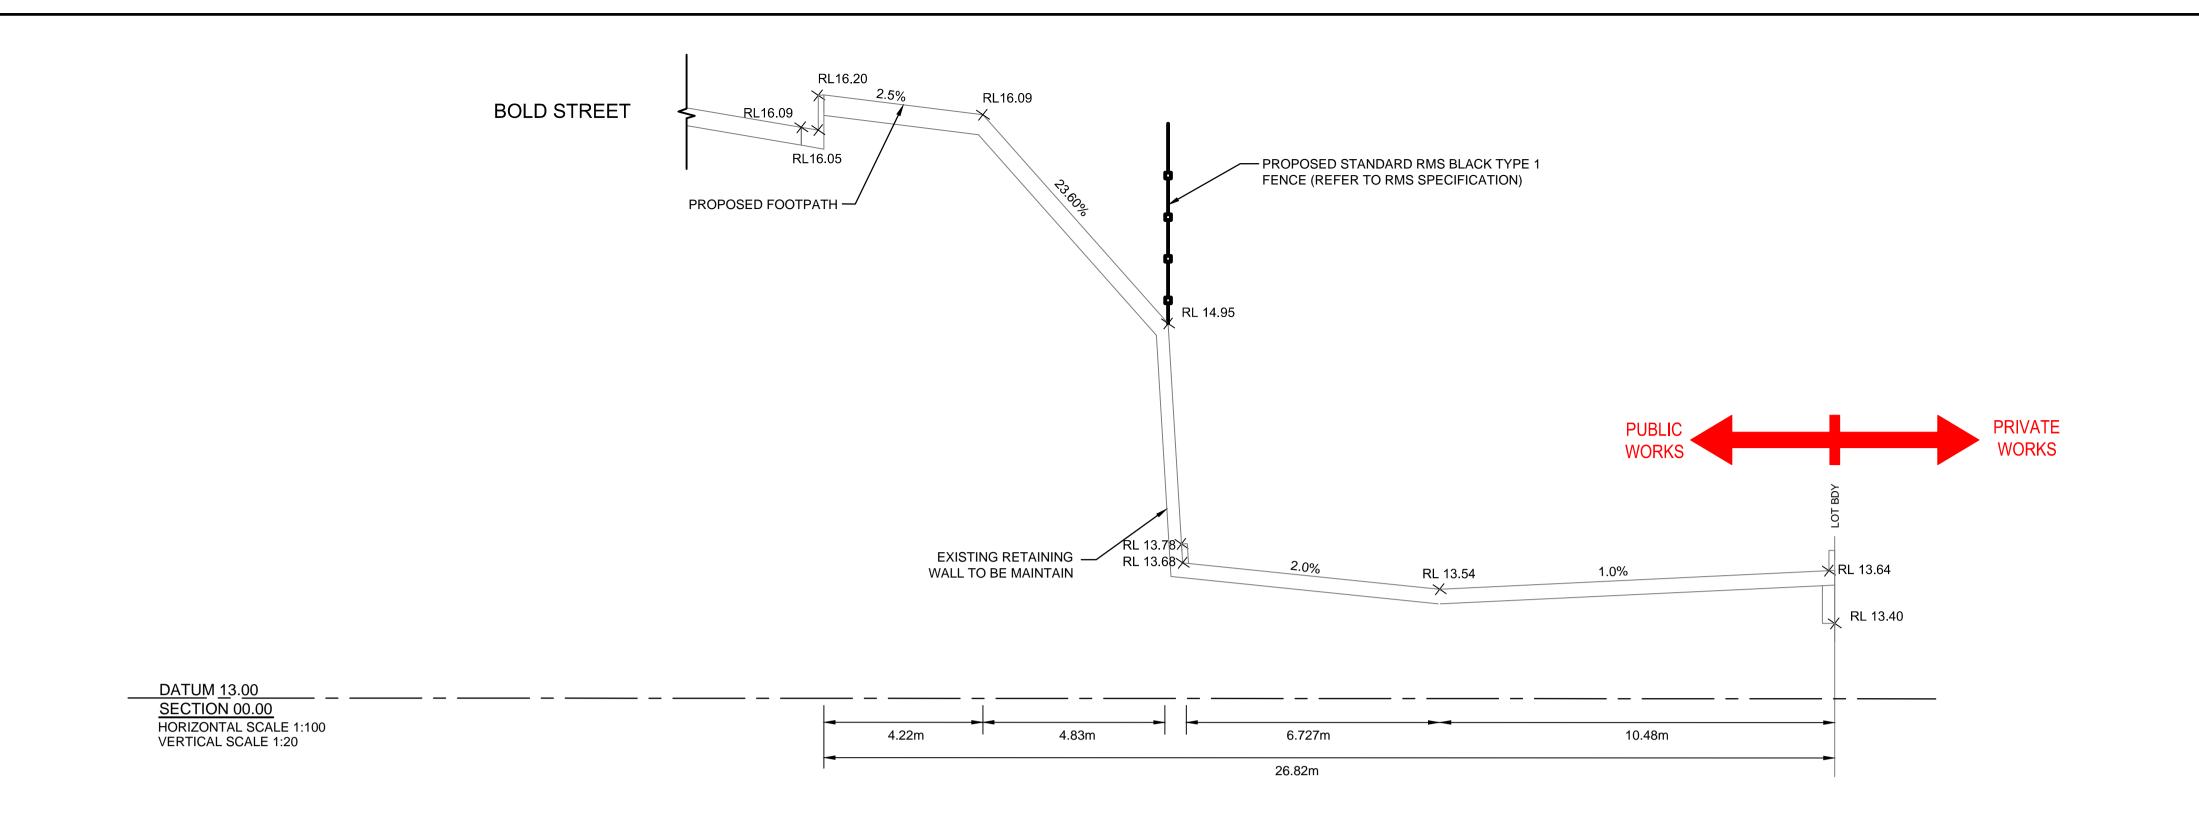
GENERAL NOTES:


- 1- PAVED FOOTPATHS OVER CONCRETE BASE TO BE INSTALLED IN ACCORDANCE WITH COUNCIL STD DRG DS40 TYPICAL FOOTWAY SECTION.
- 2- ANY NEW CONCRETE KERB & GUTTER TO BE INSTALLED IN ACCORDANCE WITH COUNCIL STD DRG D51 KERB & GUTTER & LAYBACKS.

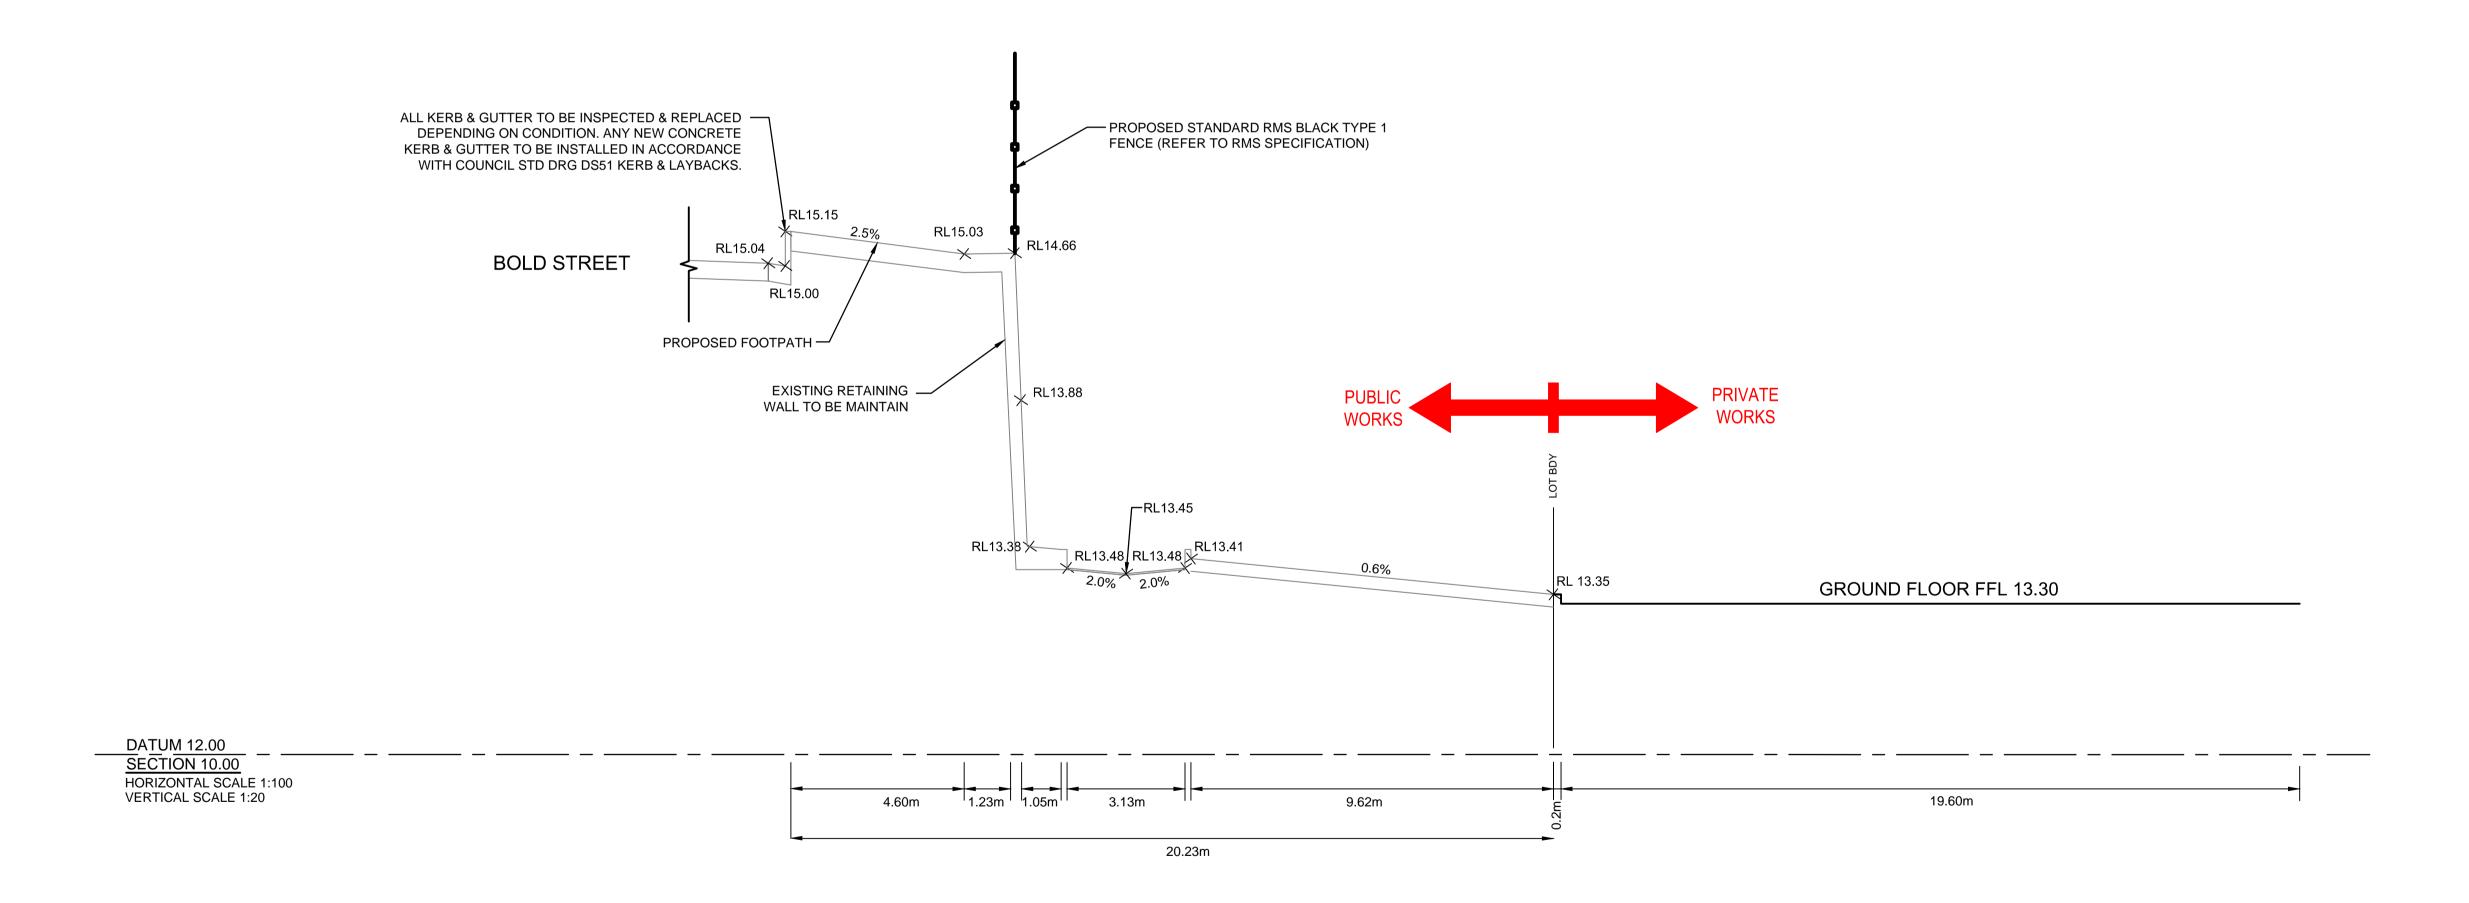



NOT FOR CONSTRUCTION

Н	COUNCIL COMMENTS	18/08/2017 JAI	WSS MBR	Architect	Client	Scale	Certification By:	AUSTRALIAN	2-6 BOLD STREET &	Drawing Title
G	COUNCIL COMMENTS	21/07/2017 CAM	MBR MBR	IDRAFT	Designer Home	0 2 4	6 m		2 0 BOLD OTTLET Q	FOOTPATH CROSS SECTIONS
F	COUNCIL COMMENTS	20/04/2017 MBR	MBR MBR		Construction Pty Ltd		Car Make	CONSULTING		
E	MINOR ARCHITECTURAL AMENDMENTS	02/12/2016 MBR	MBR MBR	Unit 43, 2 Slough Ave	Construction 1 ty Ltd	SCALE 1:100 @ A1 0 400 800	1200 mm	ENGINEERS.	PROPOSED MIXED-USE DEVELOPMENT	
D	MINOR ARCHITECTURAL AMENDMENTS	30/05/2016 MBR	MBR MBR	Silverwater NSW	Council		1/280	AUSTRALIAN PTY LTD - A.C.N. 084 059 941	STORMWATER CONCEPT PLAN	
Issue	Description	Date Drawn	Design Checked	PHONE : (02) 9648 8848	Parramatta City Council	SCALE 1:20 @ A1	Anthony Hasham	CONSULTING SHOP 2-141 CONCORD RD NORTH STRATHFIELD NSW 2137 PH: (02) 9763 1500 FX: (02) 9763 1515		Scale A1 Project No. Dwg. No. Issue
1 0	1cm at full size		20cm		1			ENGINEERS. EMAIL: info@aceeng.com.au	DEVELOPMENT APPLICATION	As Shown ACE170865.SW.DA SK03 H

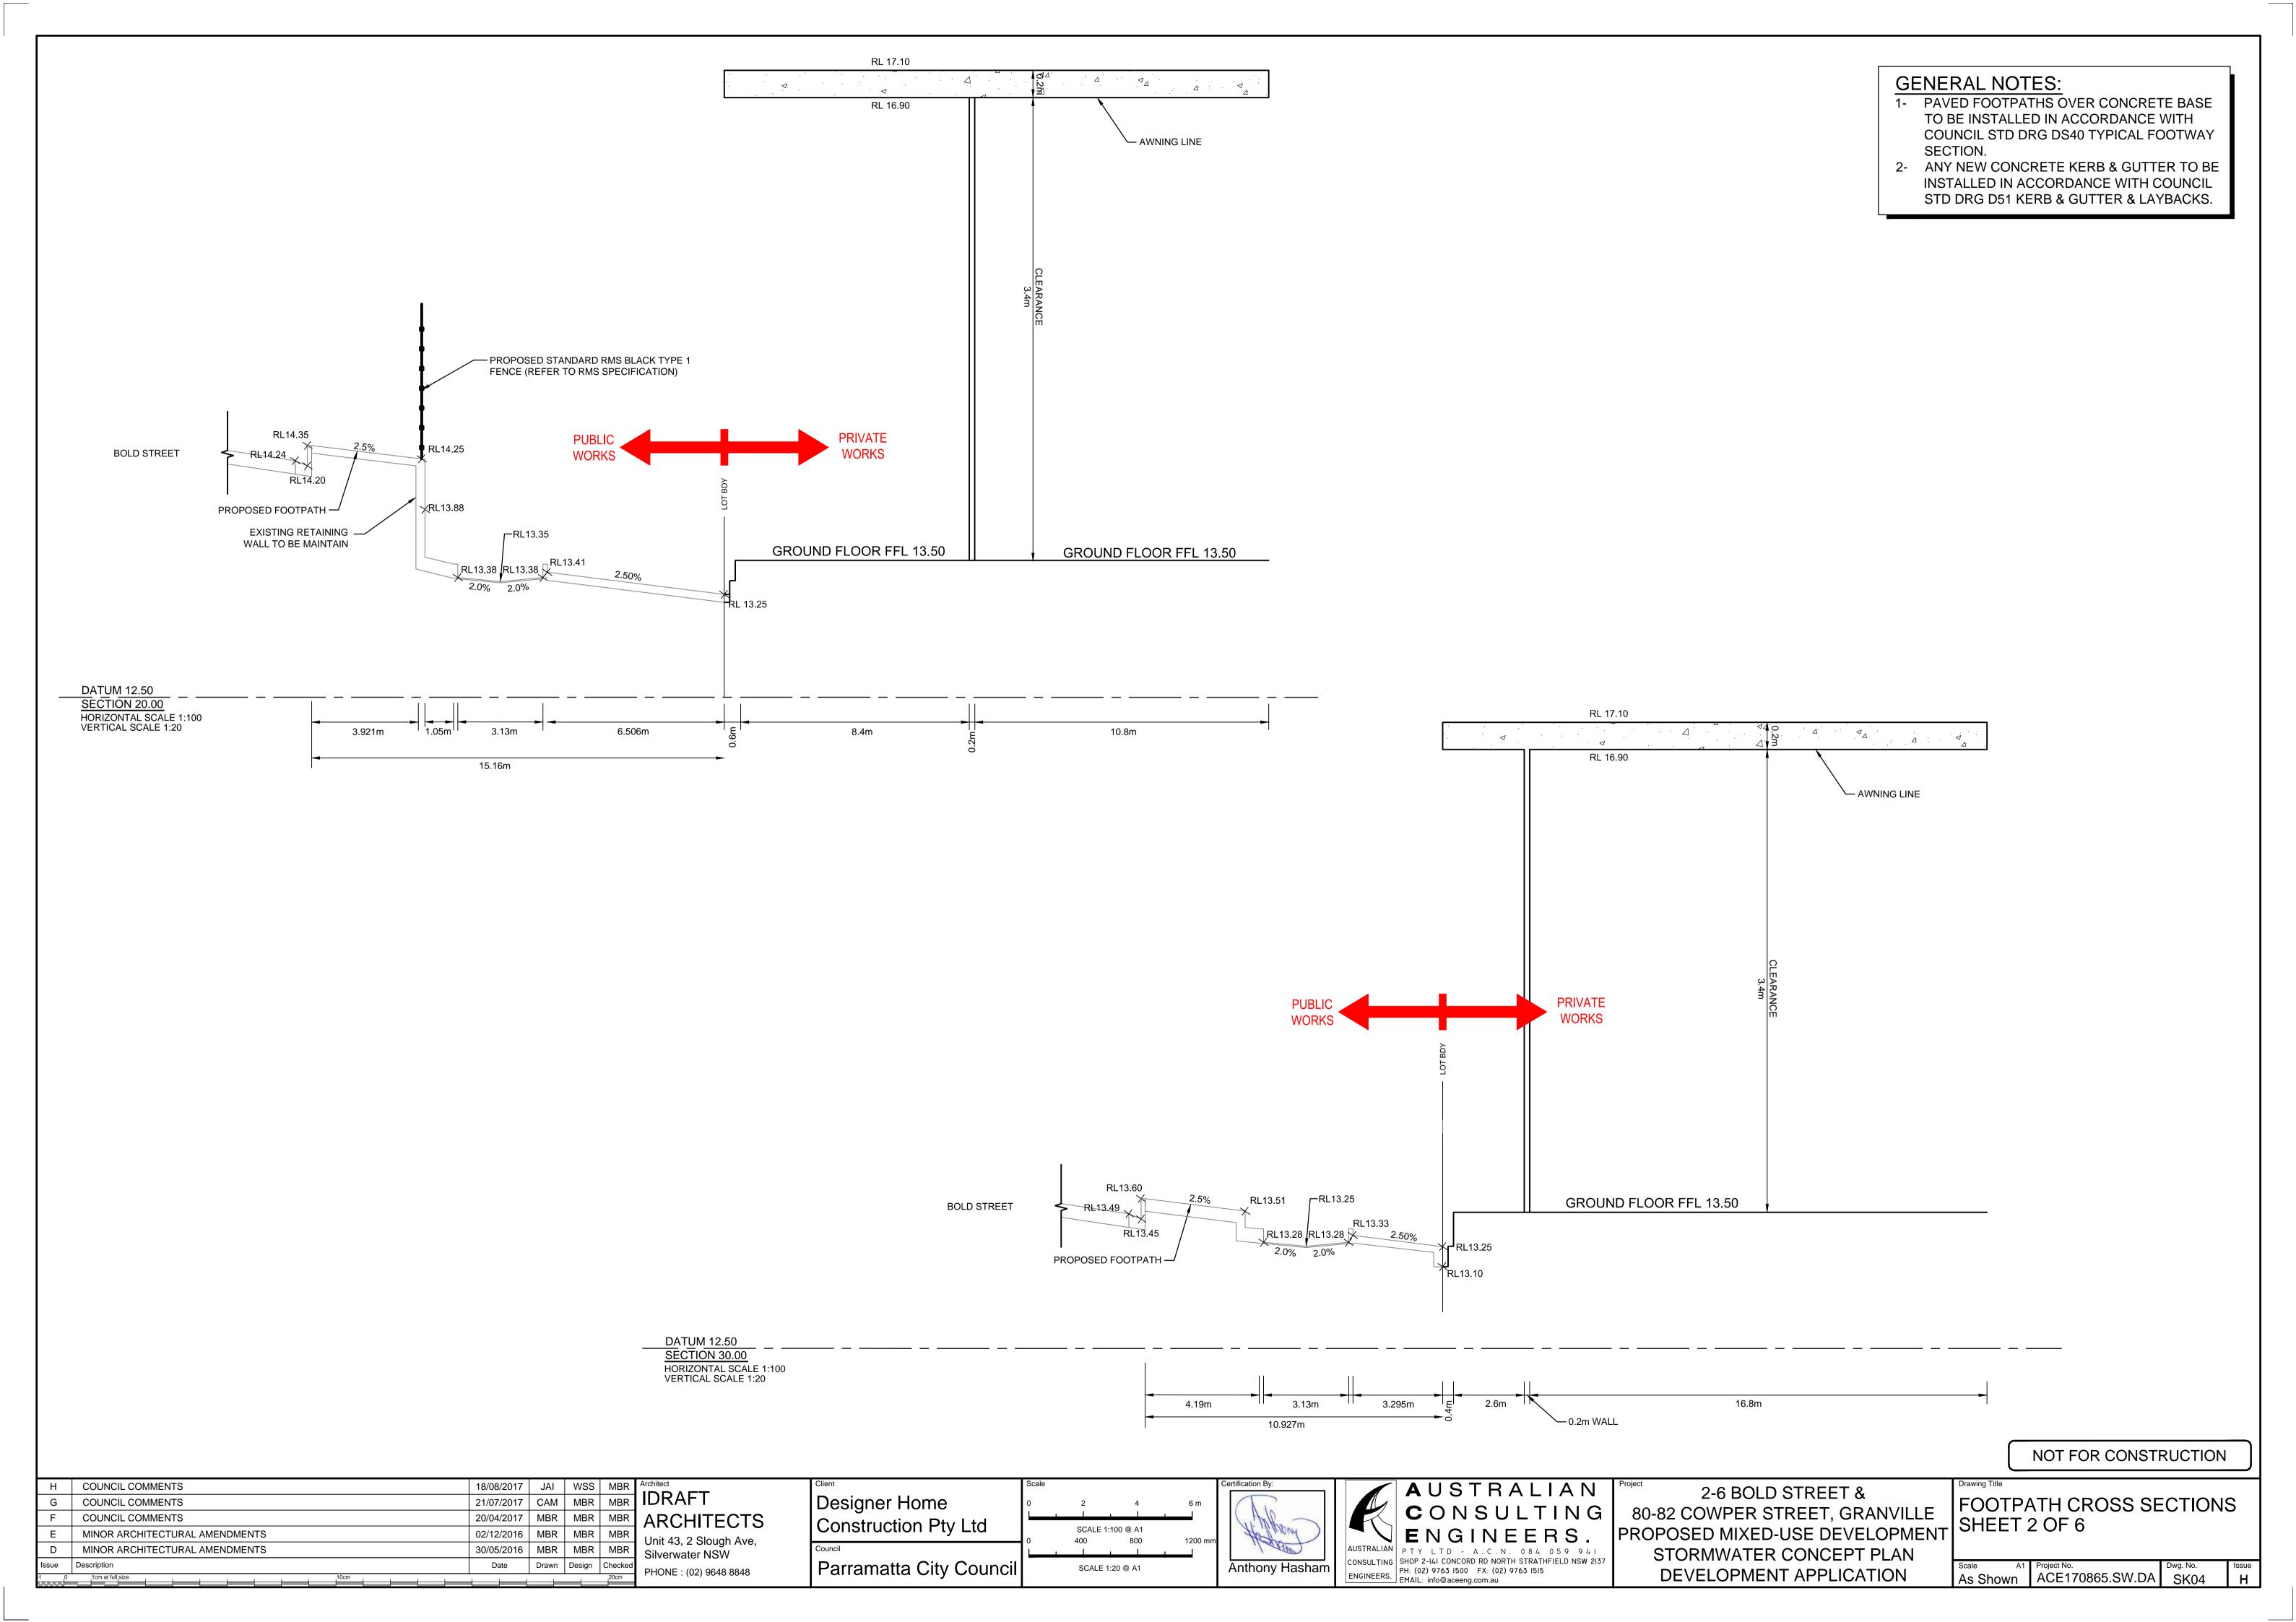

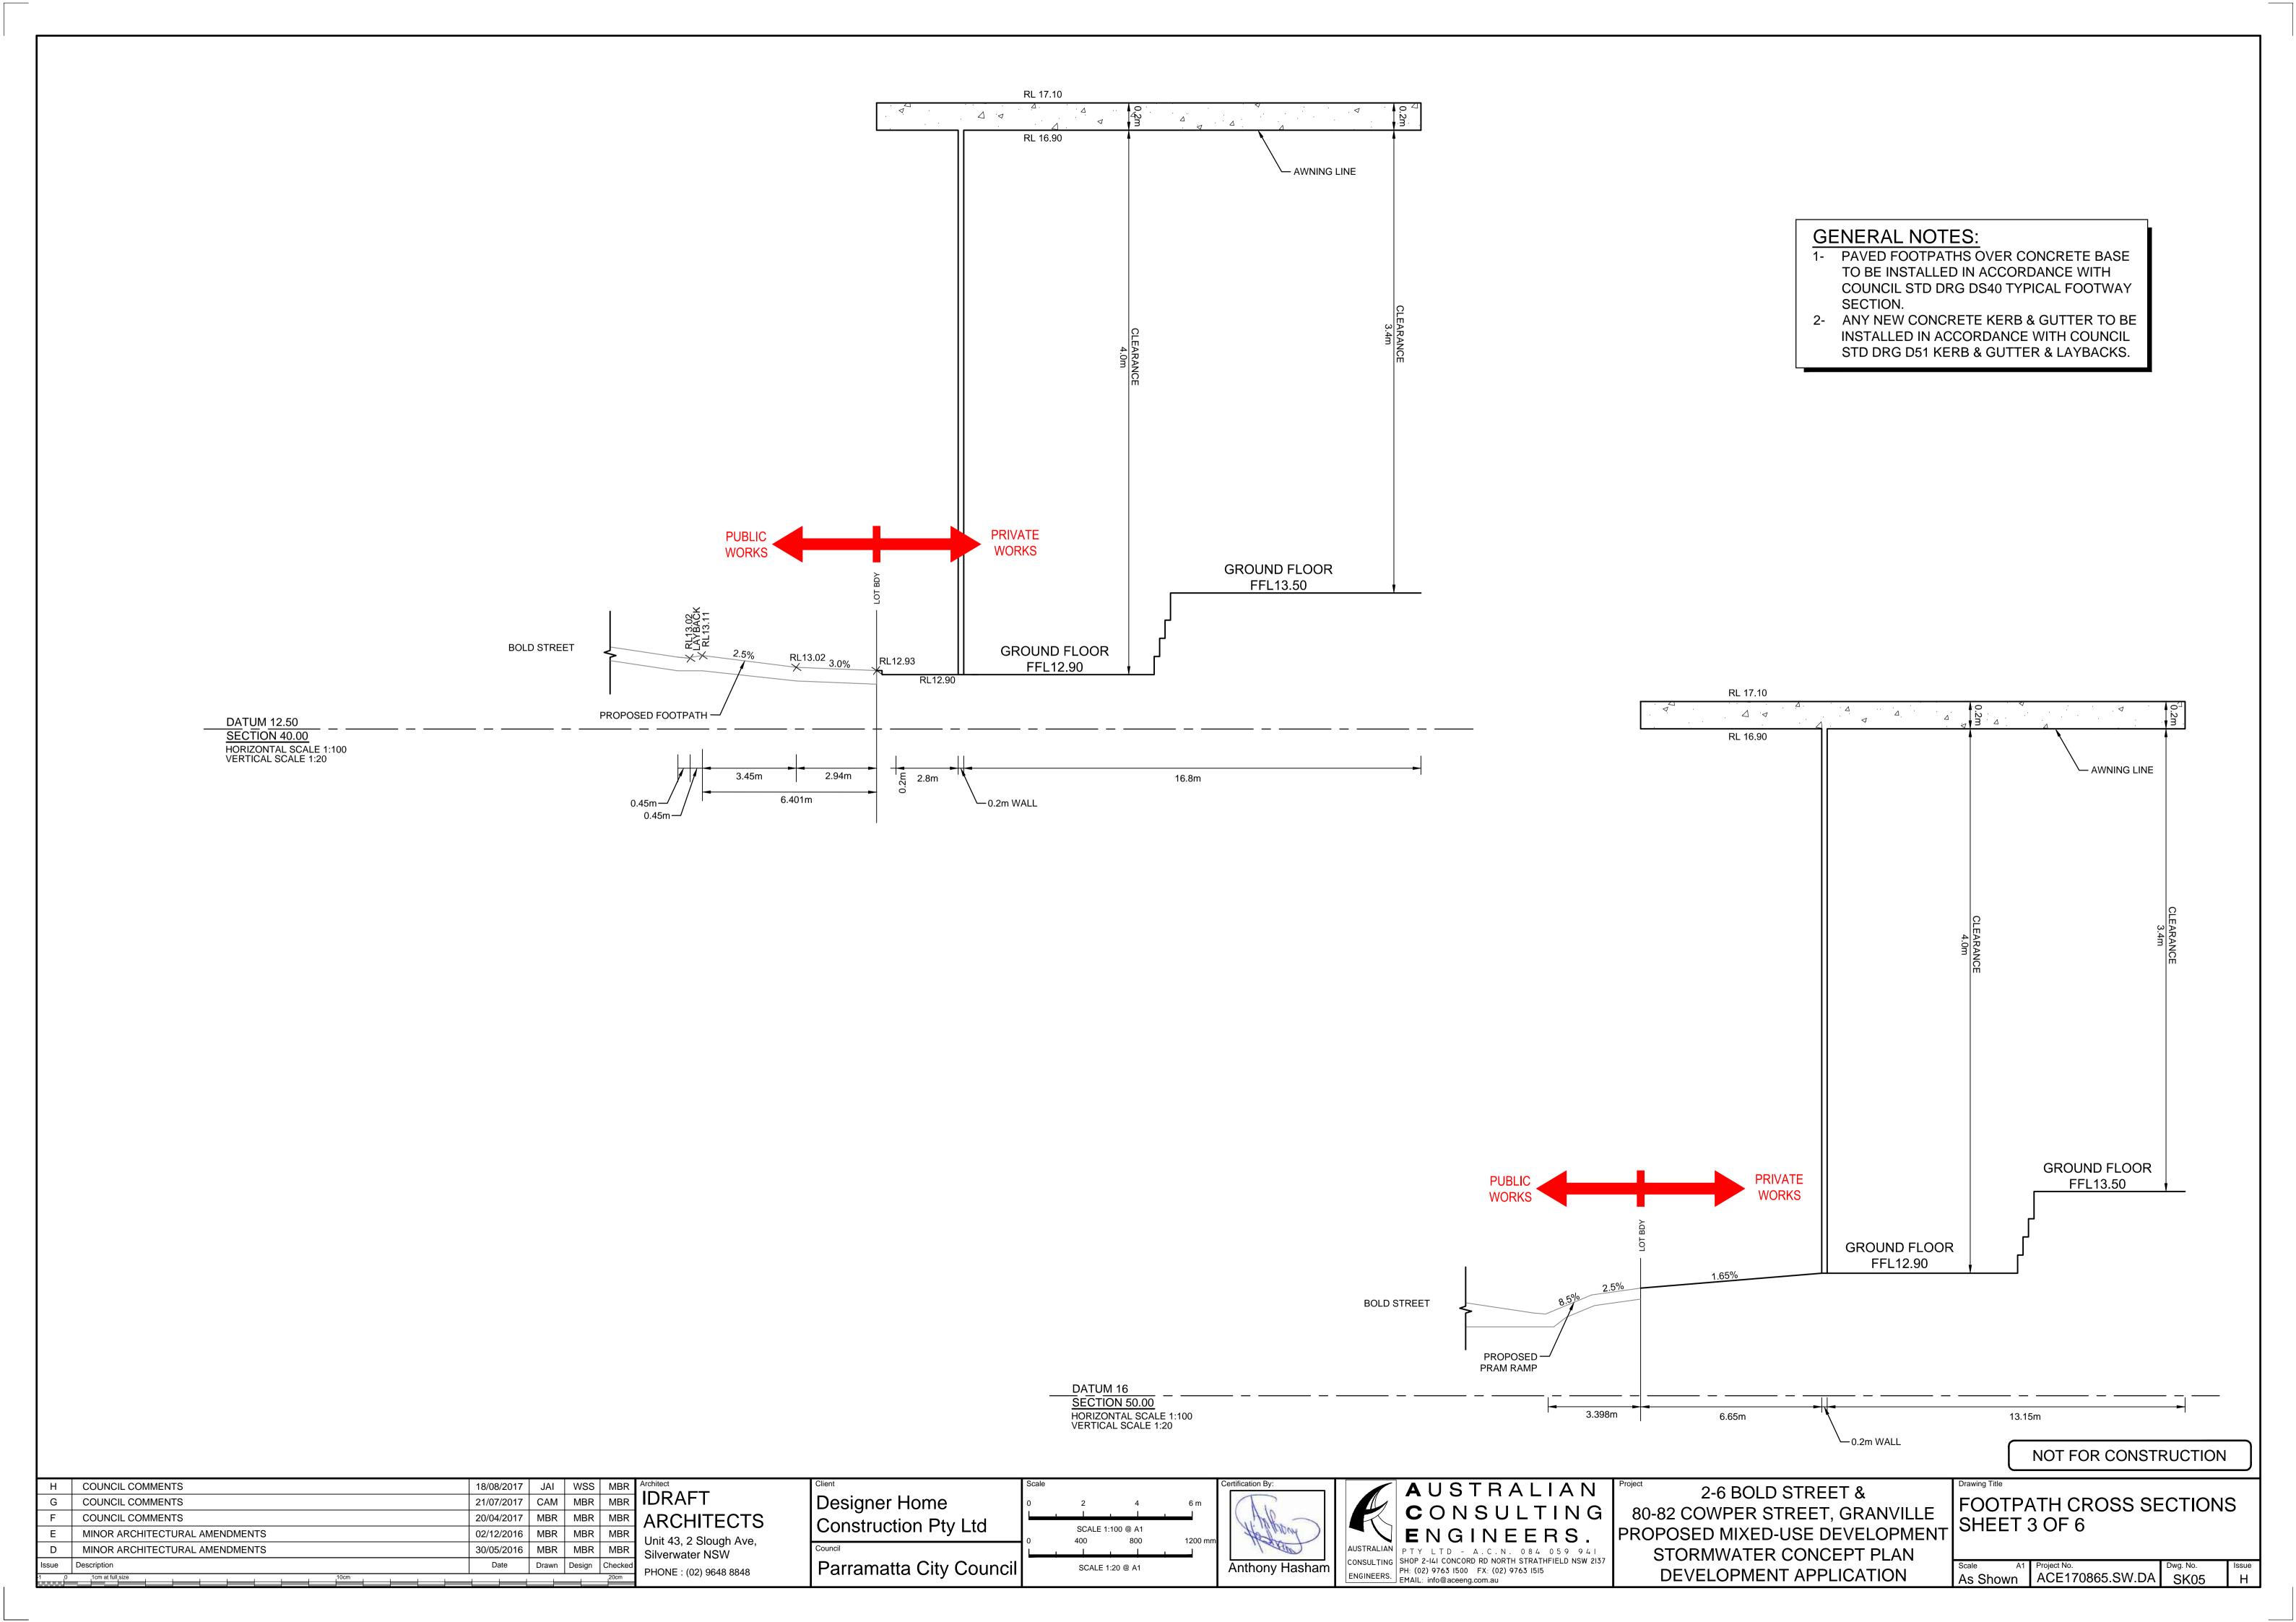


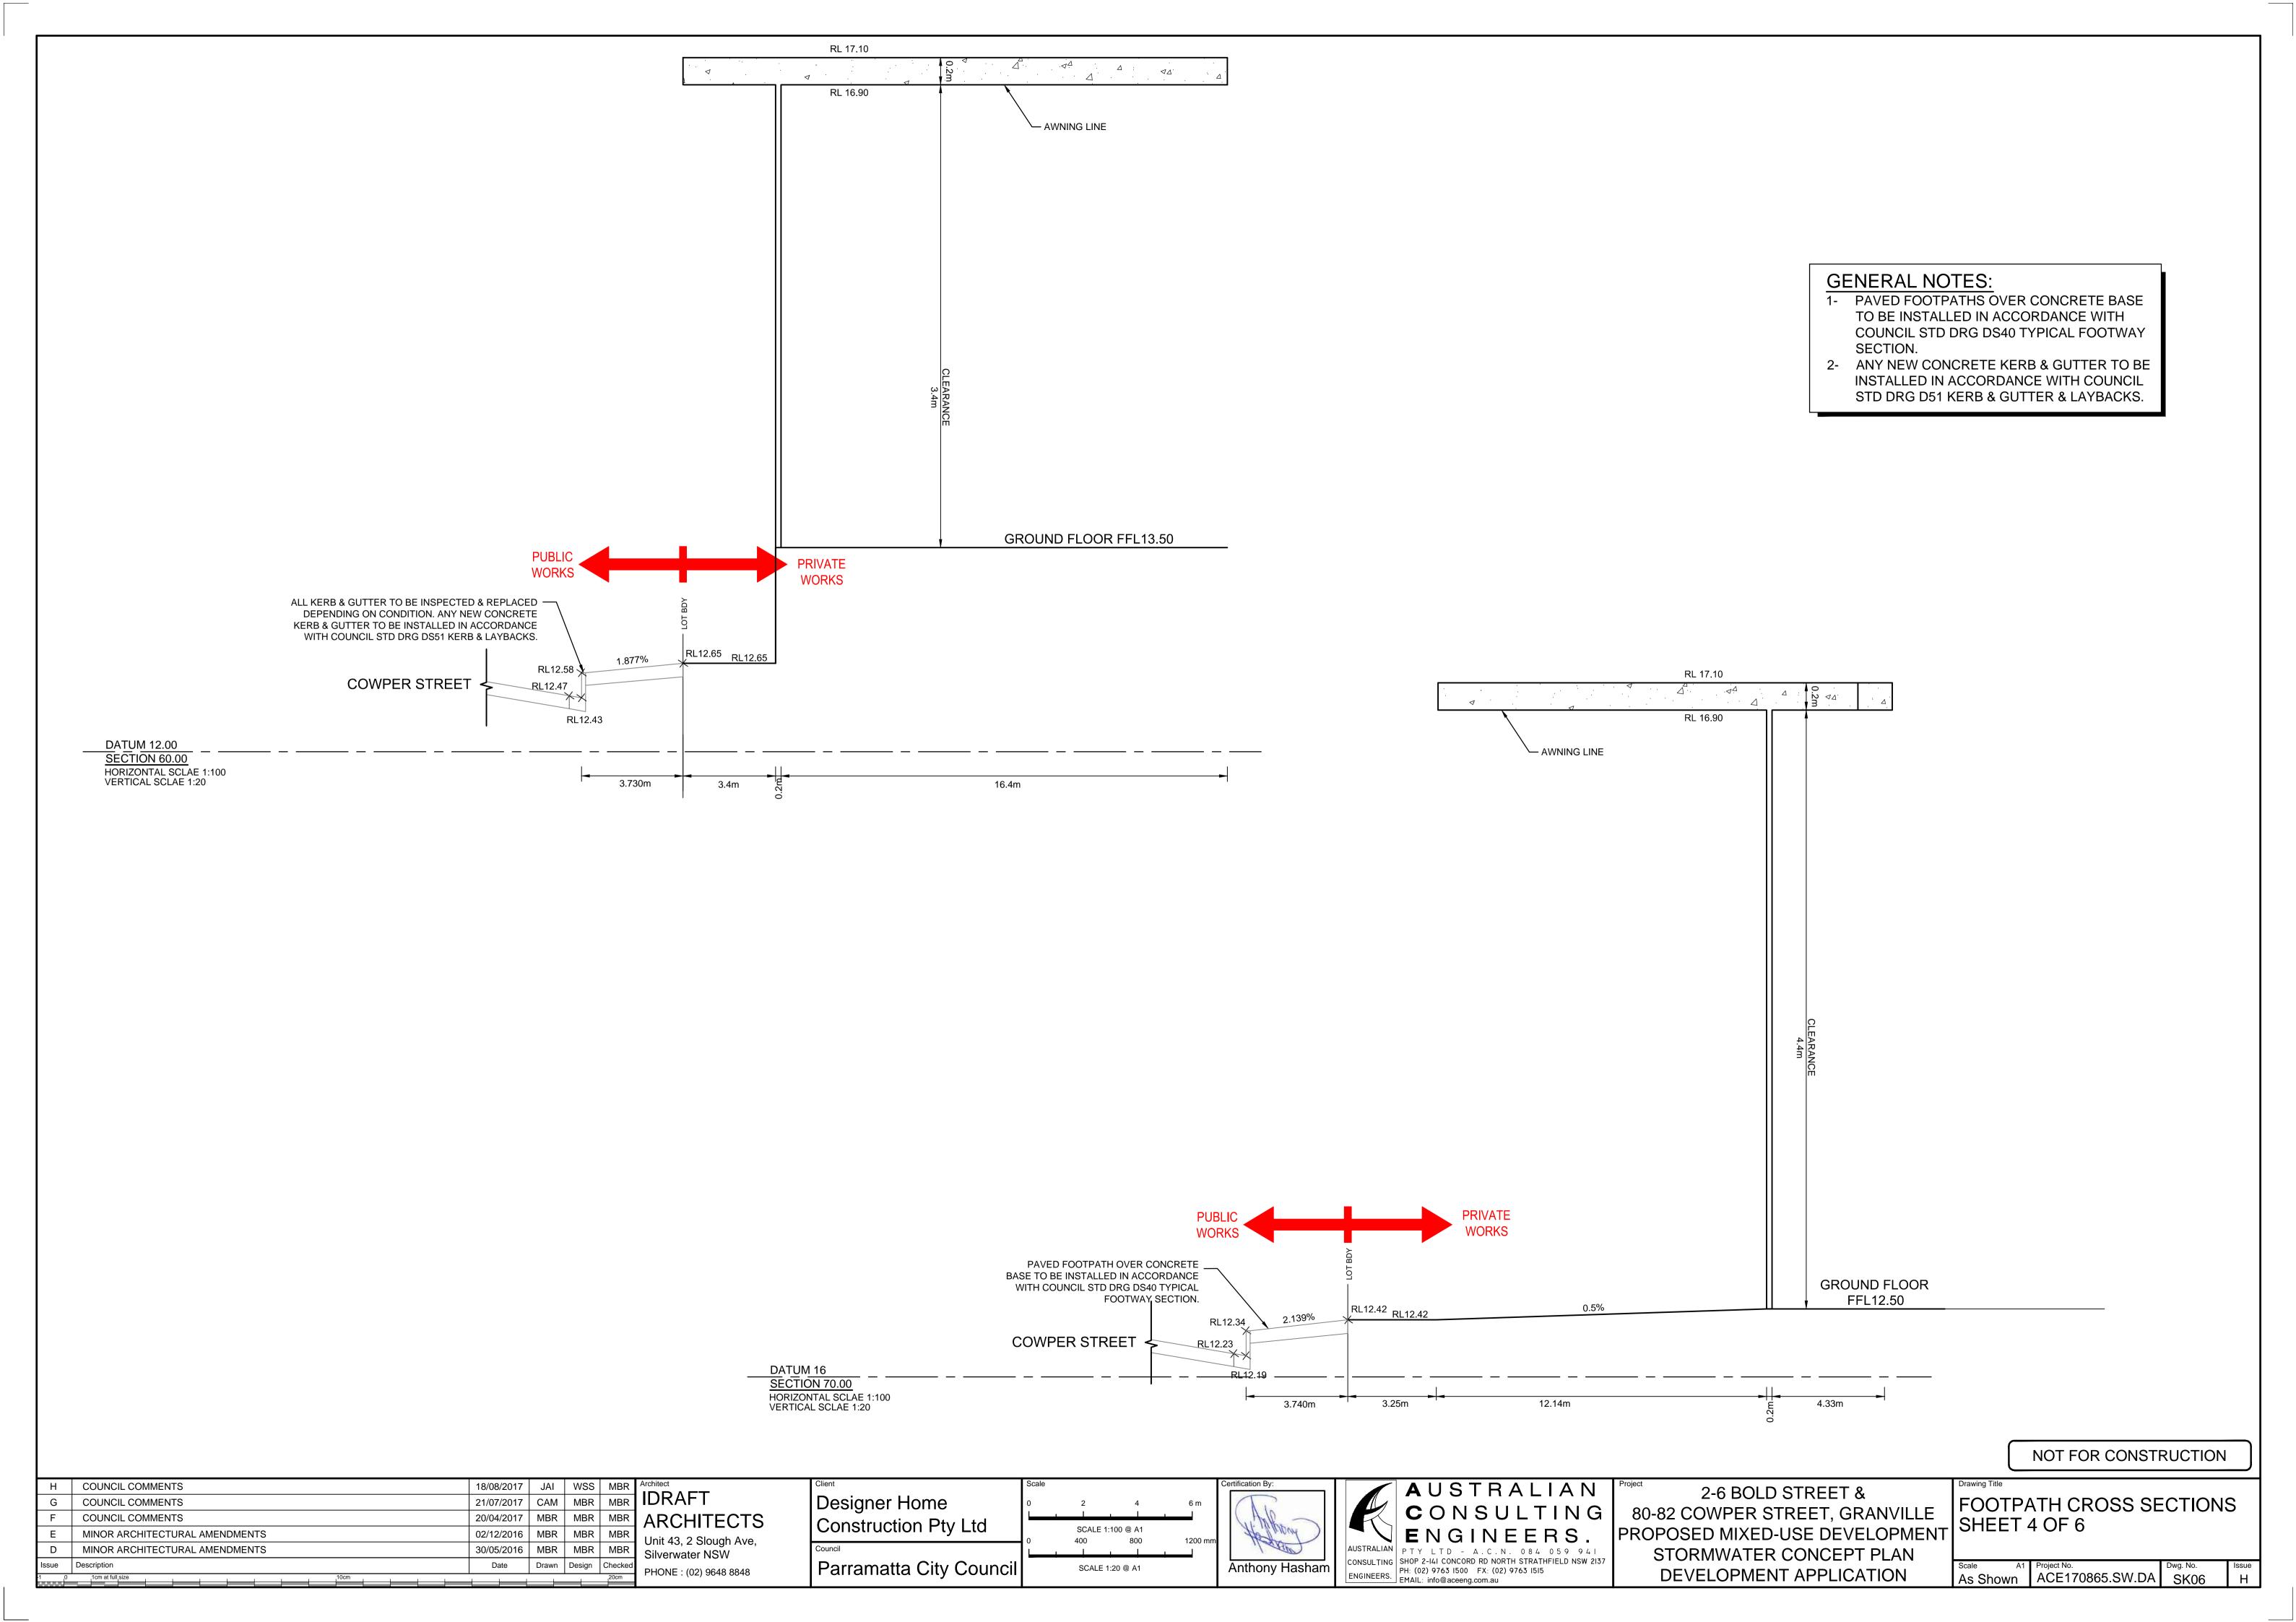

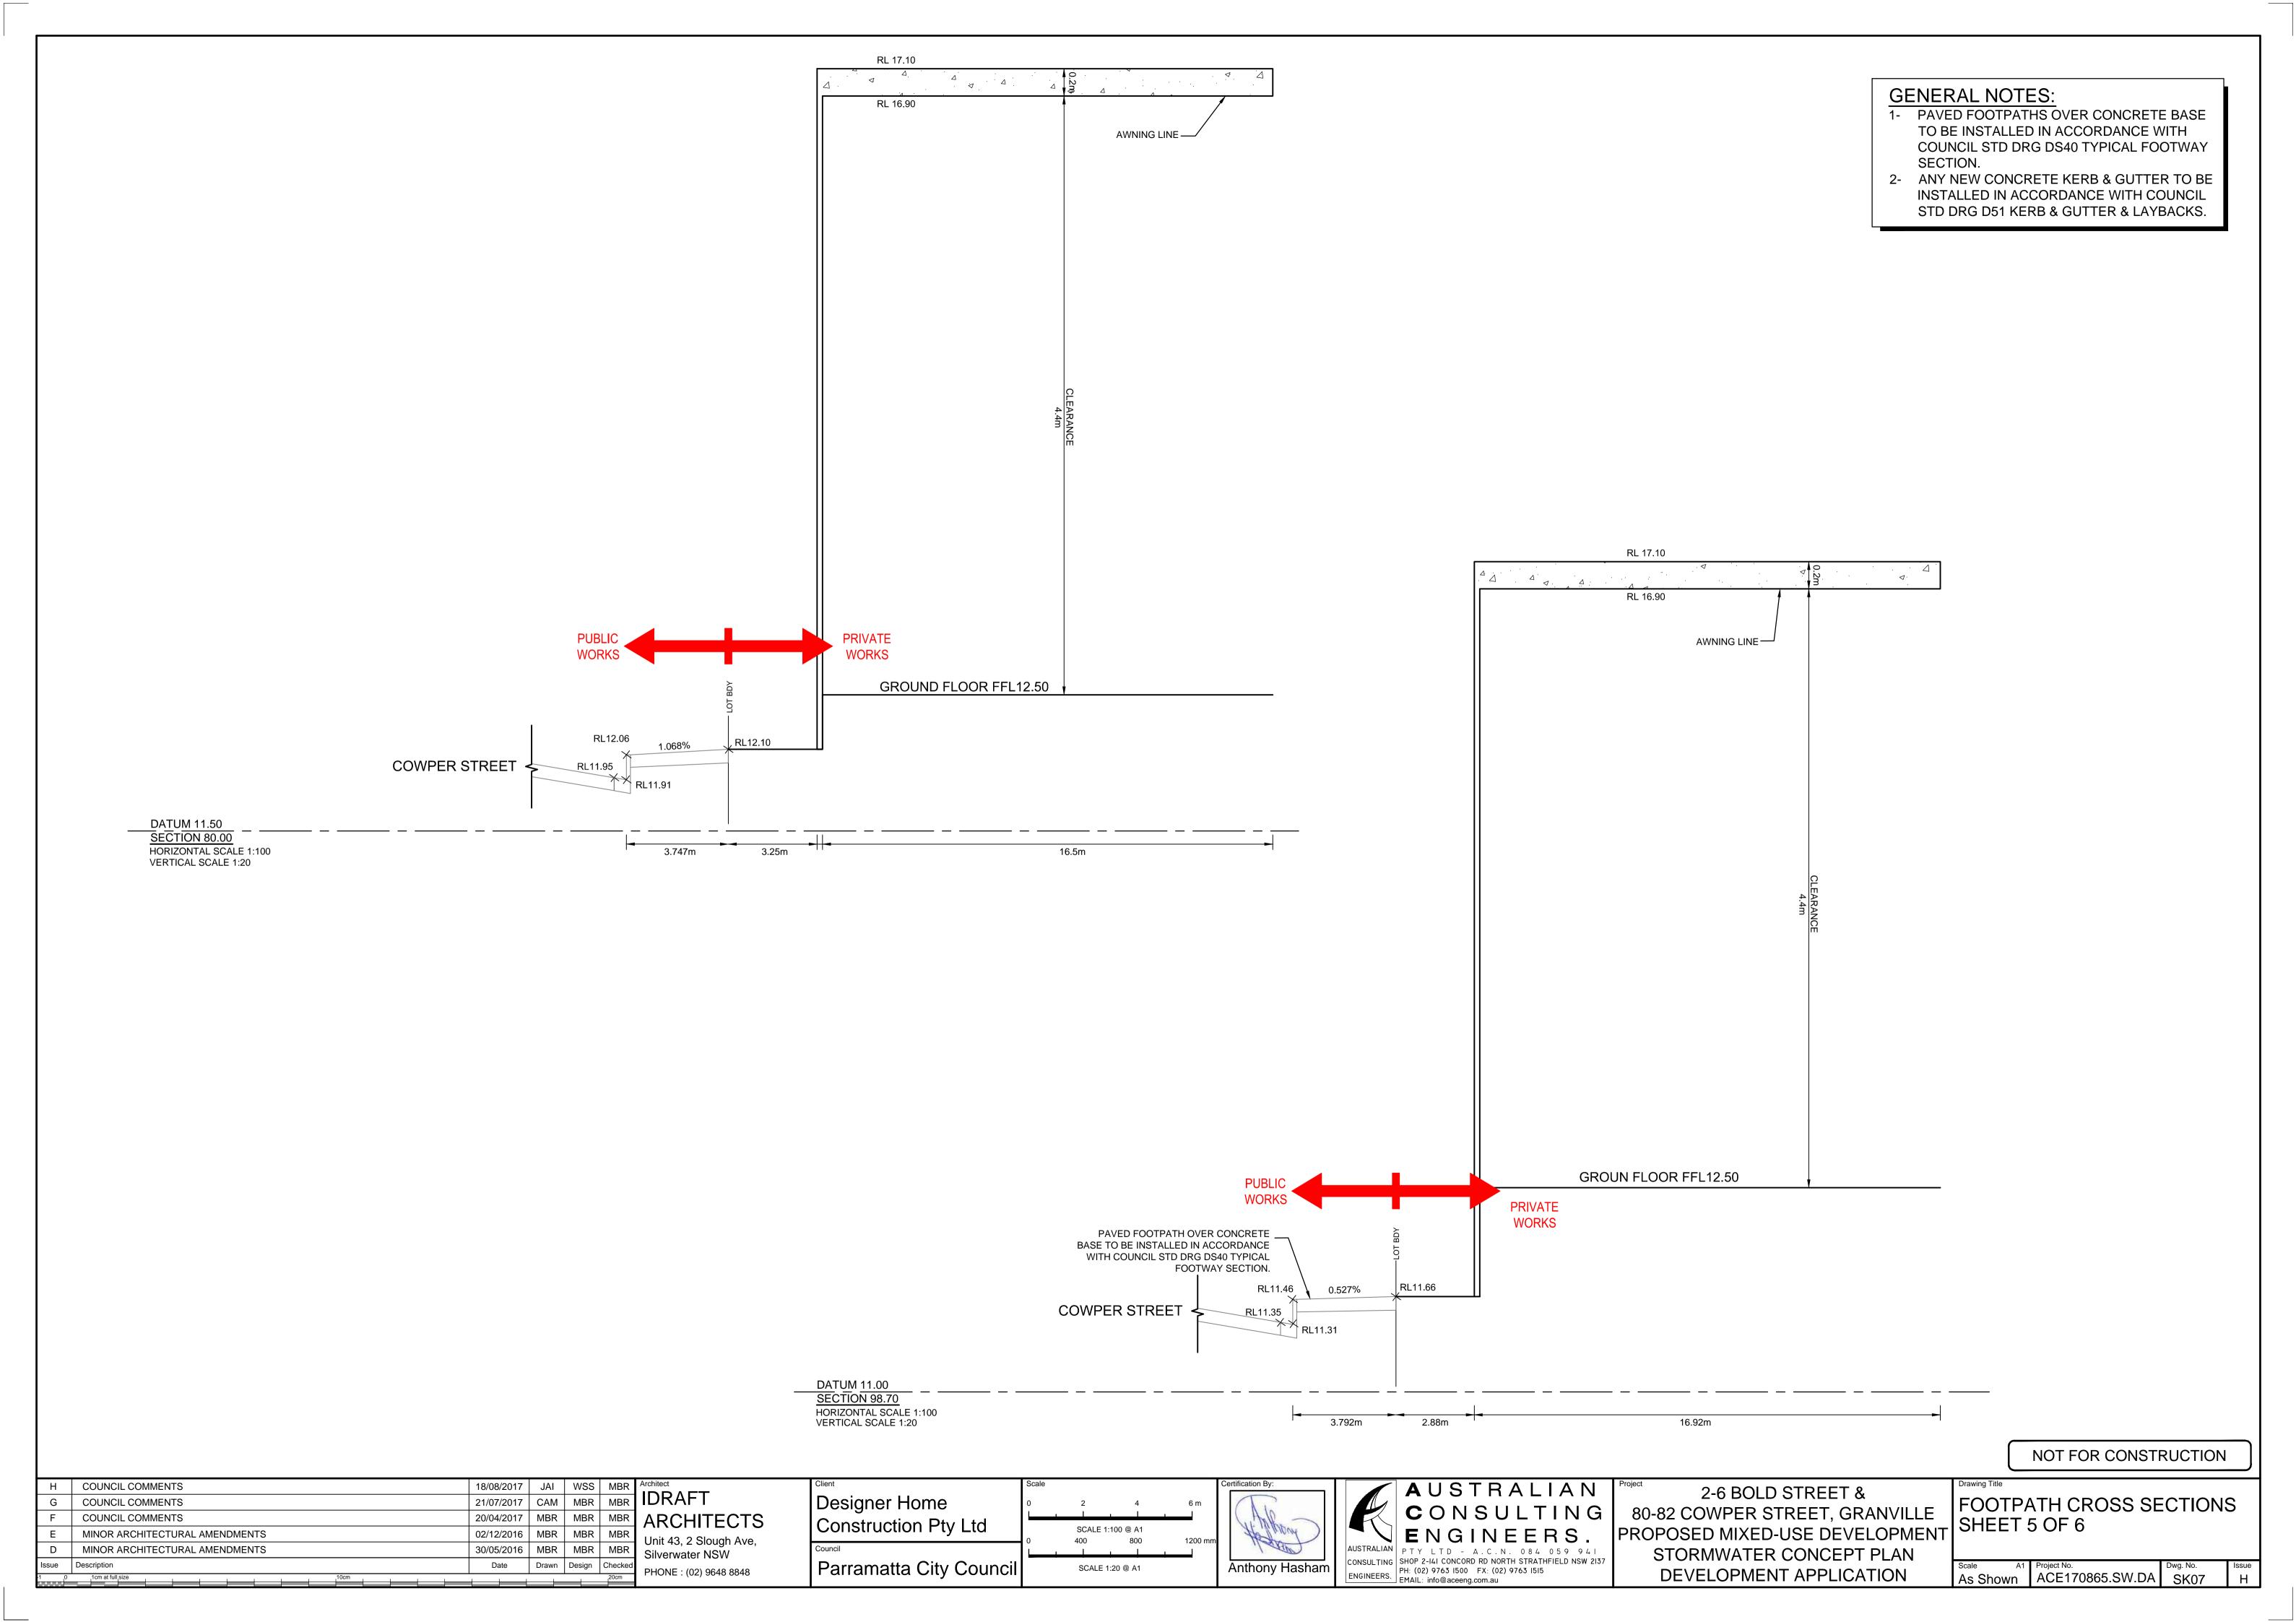

GENERAL NOTES:


- 1- PAVED FOOTPATHS OVER CONCRETE BASE TO BE INSTALLED IN ACCORDANCE WITH COUNCIL STD DRG DS40 TYPICAL FOOTWAY
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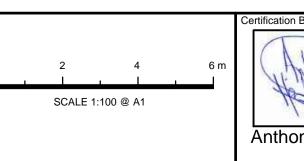

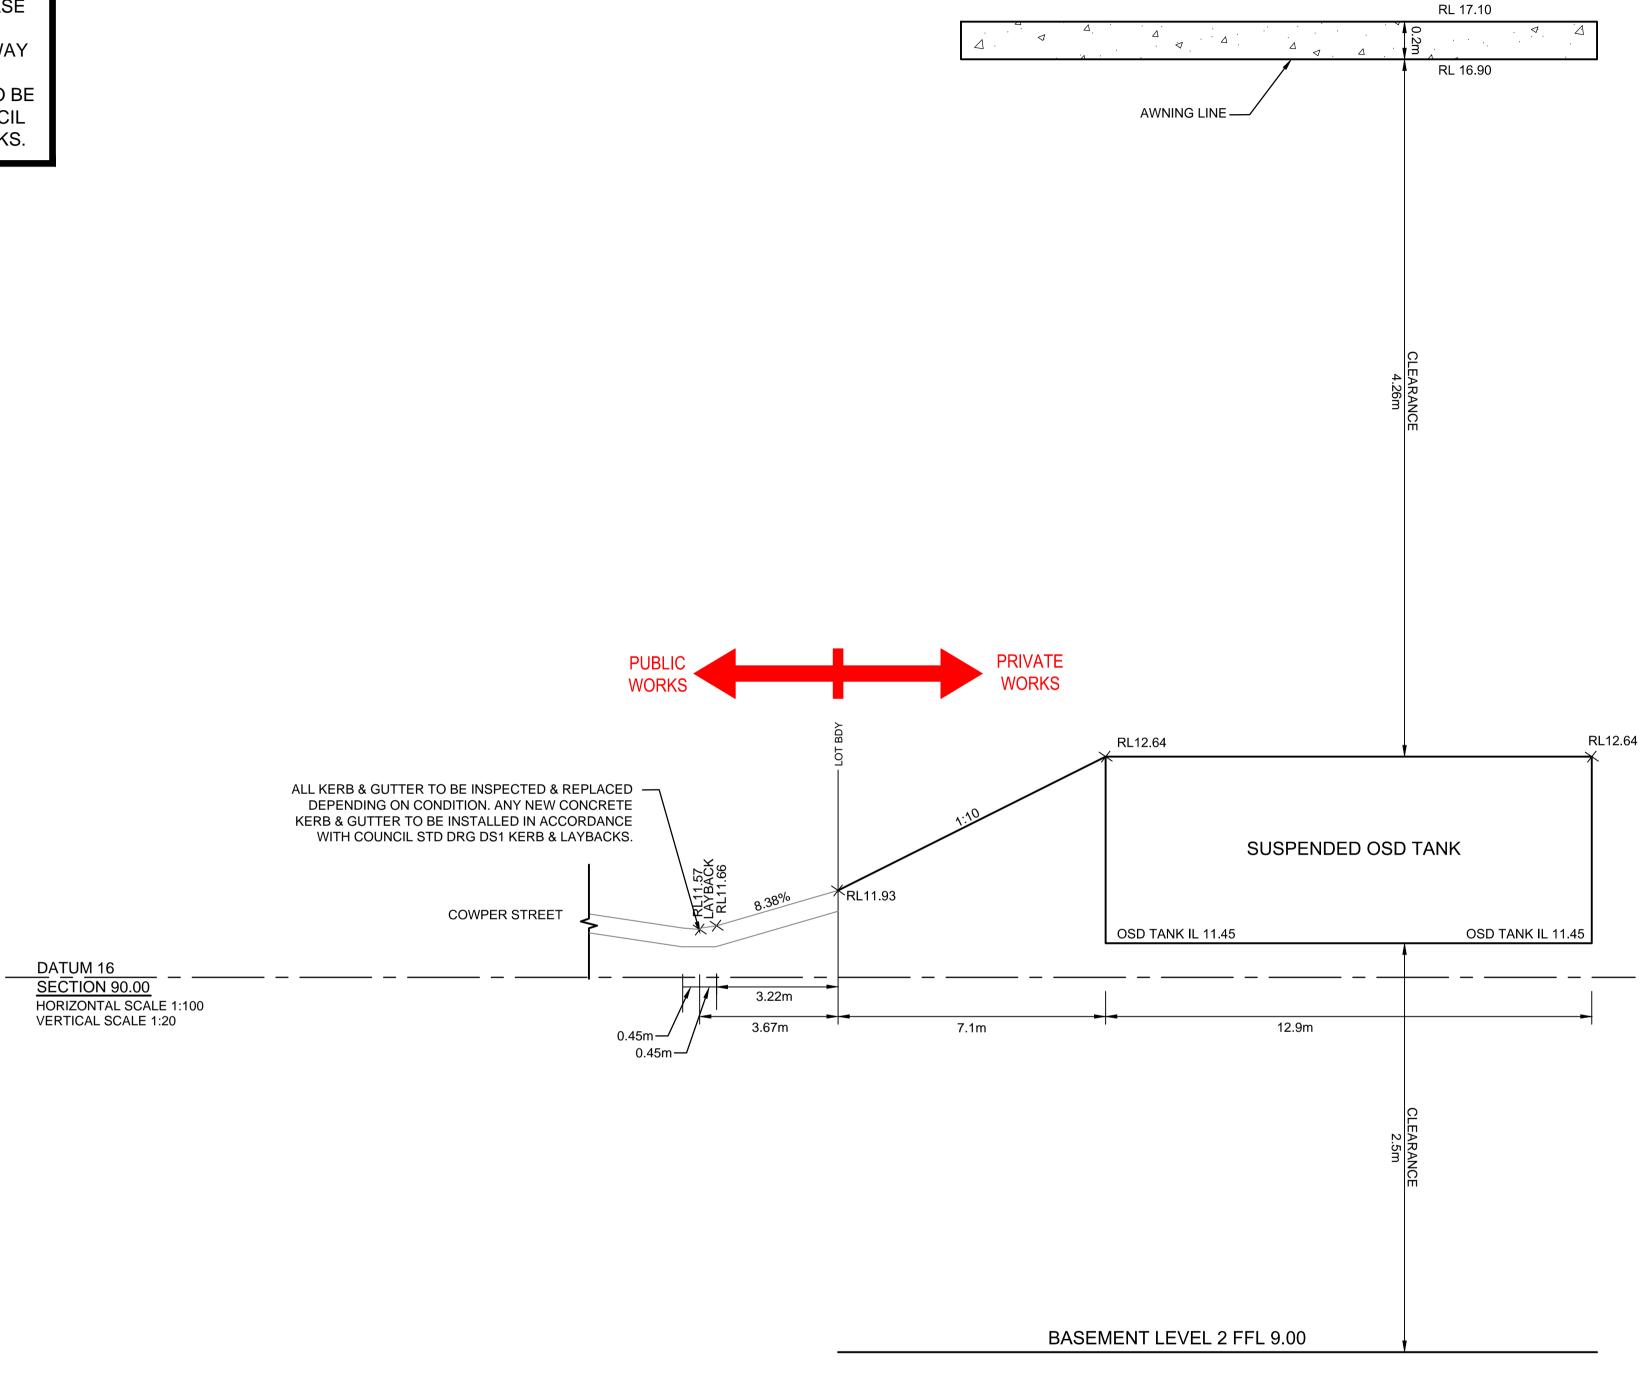
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Н	COUNCIL COMMENTS	18/08/2017	JAI	WSS	MBR	Architect
G	COUNCIL COMMENTS	21/07/2017	CAM	MBR	MBR	IDRAFT
F	COUNCIL COMMENTS	20/04/2017	MBR	MBR	MBR	ARCHITE
Е	MINOR ARCHITECTURAL AMENDMENTS	02/12/2016	MBR	MBR	MBR	Unit 43, 2 Slough
D	MINOR ARCHITECTURAL AMENDMENTS	30/05/2016	MBR	MBR	MBR	Silverwater NSV
Issue	Description	Date	Drawn	Design	Checked	
-1 0	1cm at full size	1 1 1	1		20cm	1110112 . (02) 9040

ARCHITECTS Unit 43, 2 Slough Ave, Silverwater NSW PHONE: (02) 9648 8848





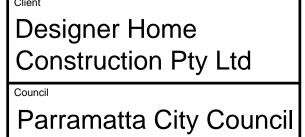






2-6 BOLD STREET & 80-82 COWPER STREET, GRANVILLE PROPOSED MIXED-USE DEVELOPMENT STORMWATER CONCEPT PLAN DEVELOPMENT APPLICATION

FOOTPATH CROSS SECTIONS SHEET 6 F 6

<u> </u>				
Scale	A1	Project No.	Dwg. No.	Issue
1:100		ACE170865.SW.DA	SK08	Η

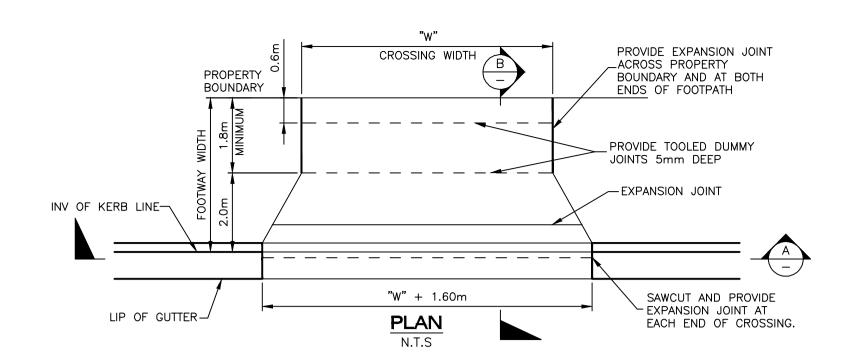

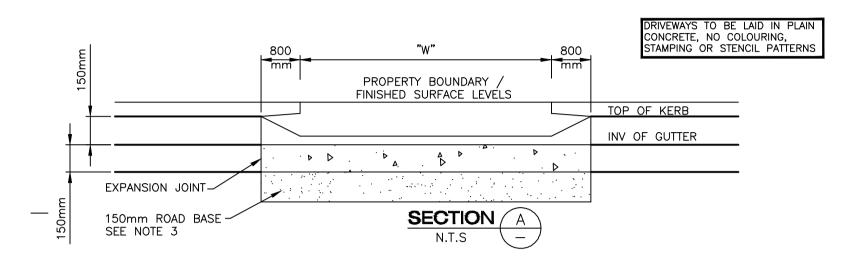


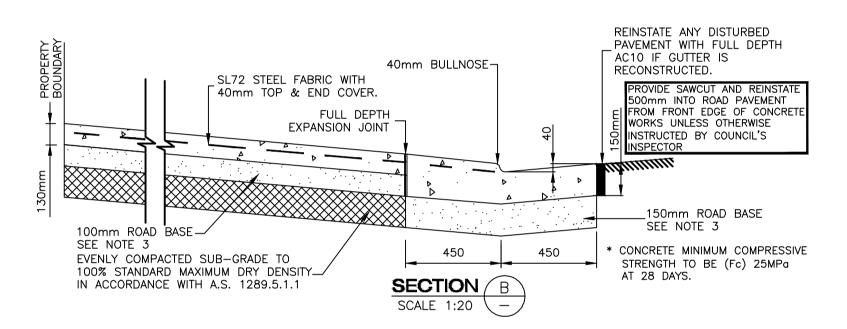

NOTES


- ALL EXISTING KERB AND GUTTER SHALL BE REMOVED PRIOR TO ANY NEW DRIVEWAY WORKS.
- VEHICULAR CROSSING LEVELS TO BE IN ACCORDANCE WITH DETAILED DRAWING.
- 3. ROAD BASE MATERIAL IS TO BE DGB20 OR SIMILAR AND COMPACTED TO 100% STANDARD MAXIMUM DRY DENSITY IN ACCORDANCE WITH A.S. 1289.5.1.1
- ALL DISTURBED AREAS TO BE TOPSOILED WITH 75mm OF APPROVED LOAM AND TURFED AS SOON AS PRACTICABLE TO ENCOURAGE REVEGETATION AND MINIMISE SOIL EROSION FROM SITE.
- EXISTING CONCRETE FOOTPAVING IS TO BE RECONSTRUCTED AS REQUIRED BY COUNCIL'S INSPECTOR OR PROJECT MANAGER TO MATCH THE CROSSING.
- THE FOOTWAY IS TO BE SHAPED AS REQUIRED BY COUNCIL'S INSPECTOR OR PROJECT MANAGER TO THE CROSSING EVENLY.
- 7. THIS PLAN DOES NOT APPLY FOR FOOTWAY WIDTHS LESS THAN 2.8m.
- 8. ALL SURFACES TO BE BROOM OR WOOD FLOAT FINISHED.

ROAD CROSSFALL WILL AFFECT MAXIMUM ALLOWABLE GRADES

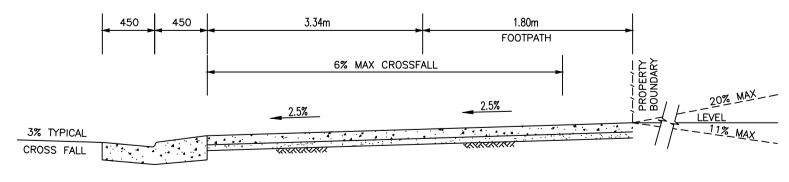

VEHICULAR CROSSING: NORMAL LEVEL TYPICAL SECTION

ALL DIMENSIONS SHOWN ARE IN MILLIMETRES

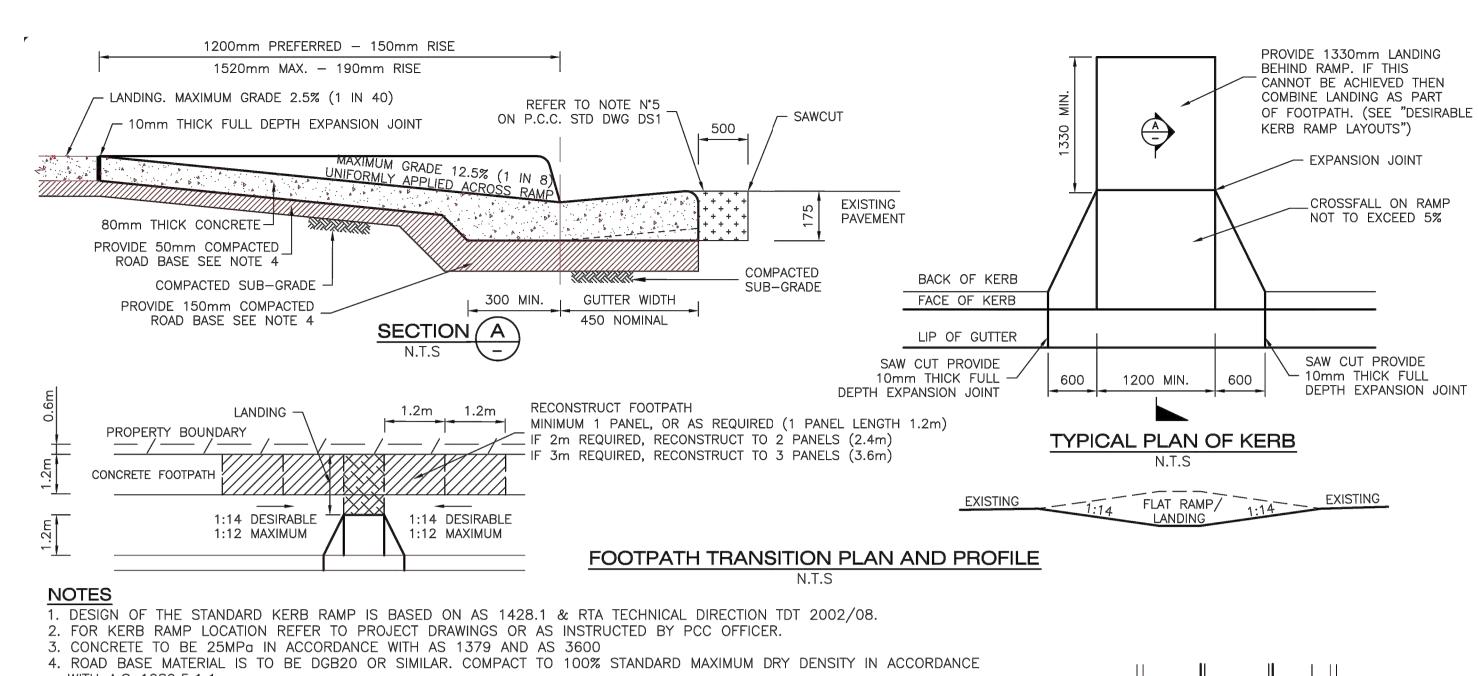

WITH A.S 1289.5.1.1

5. KERB RAMP TO BE POURED AS ONE PIECE WITH GUTTER, NO CONSTRUCTION JOINTS WILL BE ALLOWED. 6. PLAIN CONCRETE SURFACES TO BE FINISHED AS FOLLOWS;

RAMP- WOOD FLOAT FINISH GUTTER- STEEL TROWEL FINISH

7. ALL KERB RAMPS ARE TO BE ALIGNED WITH THE DESIRED DIRECTION OF PEDESTRIAN TRAVEL. (SEE "DESIRABLE KERB RAMP LAYOUTS".)

8. AT PEDESTRIAN CROSSINGS/REFUGES THE WIDTH OF THE RAMP SHOULD BE AS WIDE AS THE DEVICE OPENING. 9. SHOULD DESIGN DIMENSIONS NOT BE ACHIEVABLE, CONTACT COUNCIL'S INSPECTOR.


10. CONTACT COUNCIL'S INSPECTOR PRIOR TO COMMENCEMENT OF THE WORKS FOR

 PRE INSPECTION (TO DETERMINE SCALE OF WORKS) FORMWORK INSPECTION

- FINAL INSPECTION (PRIOR TO RELEASE OF BOND)


11. ALL DISTURBED AREAS TO BE TOPSOILED AND TURFED FLUSH WITH ALL CONCRETE WORKS.

12. ALL DIMENSIONS ARE IN MILLIMETRES UNLESS OTHERWISE SHOWN.

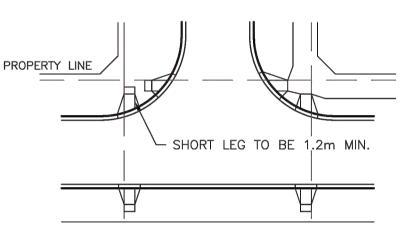

DESIRABLE KERB RAMP LAYOUTS

ASPHALT CONCRETE FOOTPATH

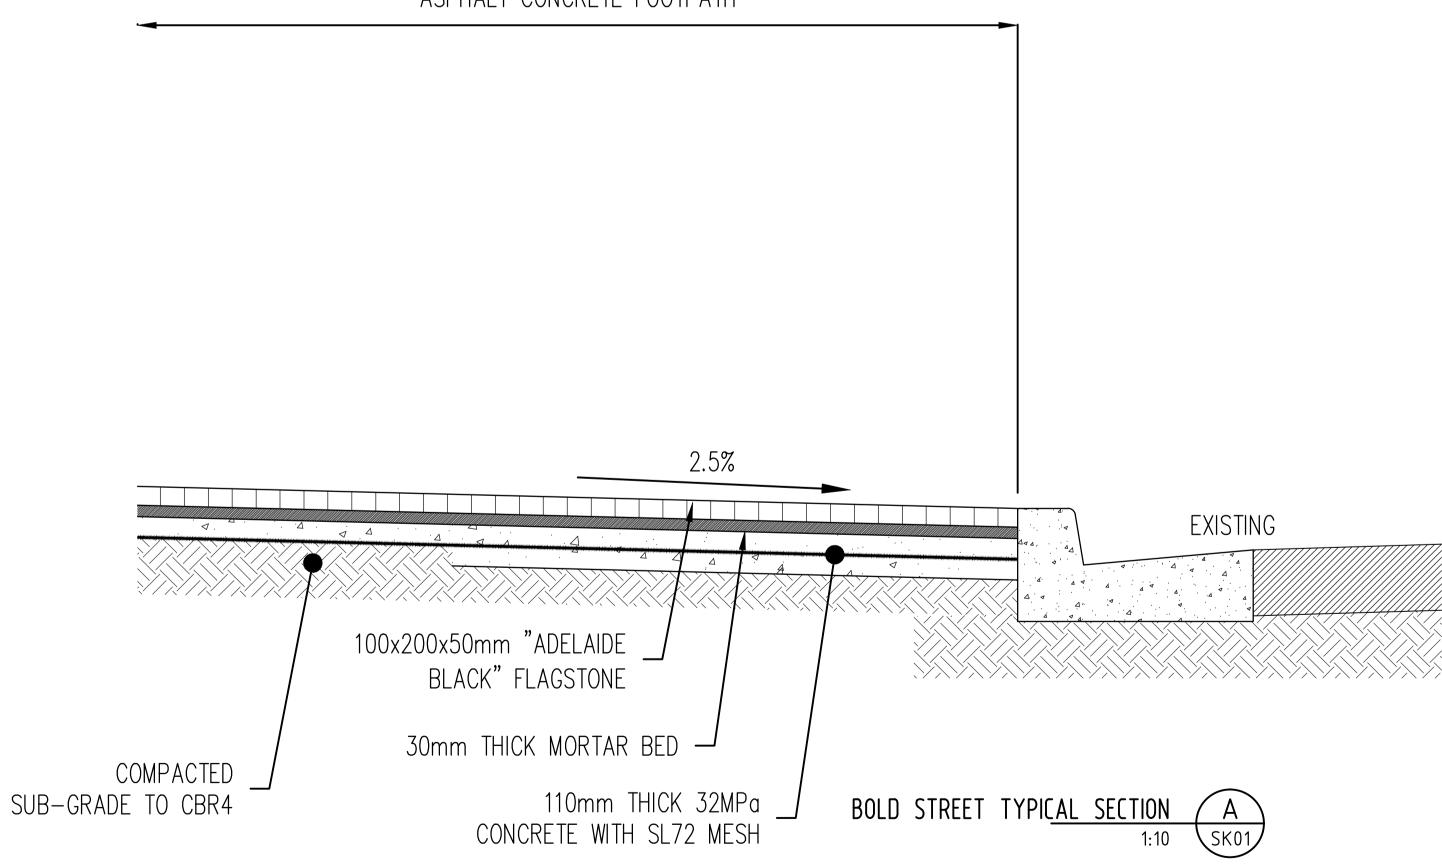


NOT FOR CONSTRUCTION


Н	COUNCIL COMMENTS	18/08/2017	JAI	WSS	MBR	Architect
G	COUNCIL COMMENTS	21/07/2017	CAM	MBR	MBR	IDR
F	COUNCIL COMMENTS	20/04/2017	MBR	MBR	MBR	AR(
Е	MINOR ARCHITECTURAL AMENDMENTS	02/12/2016	MBR	MBR	MBR	Unit 4
D	MINOR ARCHITECTURAL AMENDMENTS	30/05/2016	MBR	MBR	MBR	Silver
ssue	Description	Date	Drawn	Design	Checked	
.0	1cm at full size 10cm				.20cm	1 11011

RAFT RCHITECTS 43, 2 Slough Ave, erwater NSW NE: (02) 9648 8848

Designer Home Construction Pty Ltd

Parramatta City Council

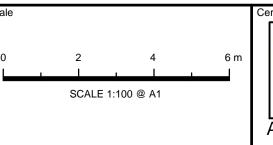

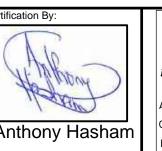




2-6 BOLD STREET & 80-82 COWPER STREET, GRANVILLE PROPOSED MIXED-USE DEVELOPMEN STORMWATER CONCEPT PLAN **DEVELOPMENT APPLICATION**

CONSTRUCTION NOTES AND DETAILS

Project No. Dwg. No. ACE170865.SW.DA SK09

50mm depth of mulch to mass planted tree pit finish flush to footpath & kerb level. Street tree planting details refer to CoP standards. 30mm AC**7** asphalt wearing course. 80mm fibrecrete (25MPa) blindinglayer equivalent to SL82 as sprcified 50mm depth DGB20 base course compacted to 100%MDD as specified. 30x30x6mm hot dip galvanised steel angle fixed on concrete slab with 70mm Ø galvanised DynaBolts at max. 600mm centres.

TYPICAL STEEL EDGE DETAIL - SECONDARY GRANITE TREATMENT

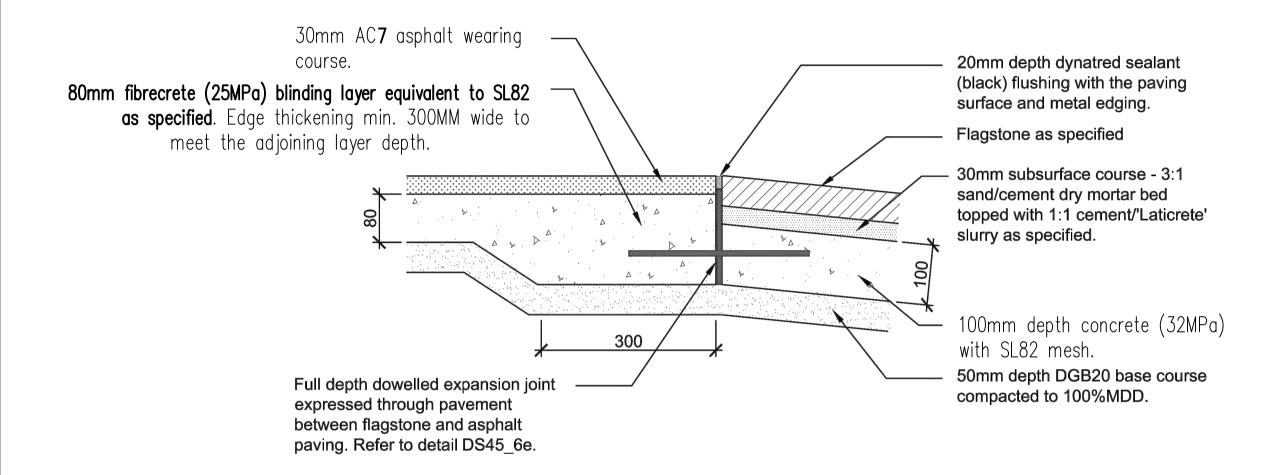

DETAIL KERB RAMP CROSS SECTION - SECONDARY GRANITE TREATMENT

IJ - Isolation Joint

10mm wide x full depth foam expansion joint, Ableflex or form expansion joint to extend to 20mm below FFL to accommodate 20mm depth black silicone joint sealant. Refer to DS45_6c.

EJ - Expansion Joint

2000 - 2400


10mm wide x full depth subsurface foam expansion joint, Ableflex or similar approved. Finish foam expansion material 20mm below FFL to allow for 20mm depth black silicone joint sealant. Refer to DS45_6d. **DEJ - Dowelled Expansion Joint**

300mm long R16 galvanised dowels capped and installed at 600mm centres perpendicular to expansion joint and parallel to pavement centreline and finished surface. Use of proprietary sleeve may be required. Refer to DS45_6e.


2000 - 2400

Asphalt surface layer as specified. 32MPa concrete as 10mm wide full depth specified. foam expansion joint. Ableflex or a similar 50mm subbase approved. course as specified


TYPICAL ISOLATION JOINT DETAIL - SECONDARY GRANITE TREATMENT

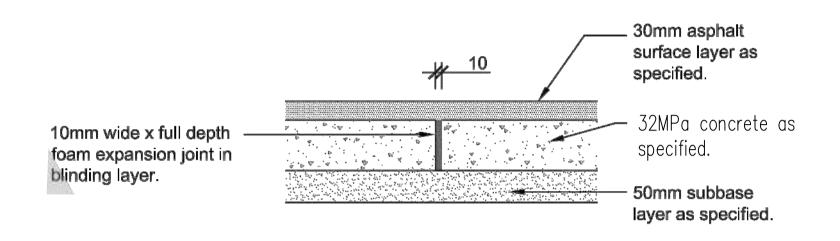


TYPICAL EXPANSION JOINT DETAIL - SECONDARY GRANITE TREATMENT

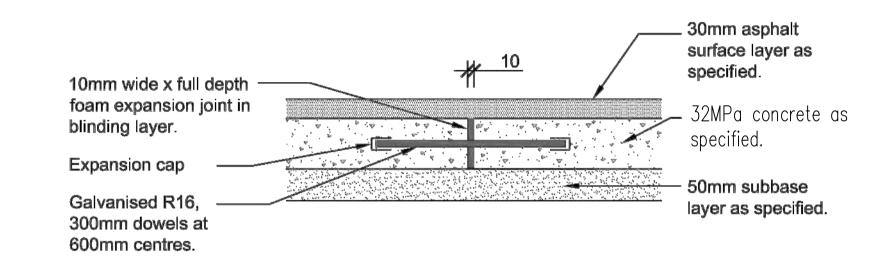

TYPICAL DOWELLED EXPANSION JOINT DETAIL - SECONDARY GRANITE TREATMENT

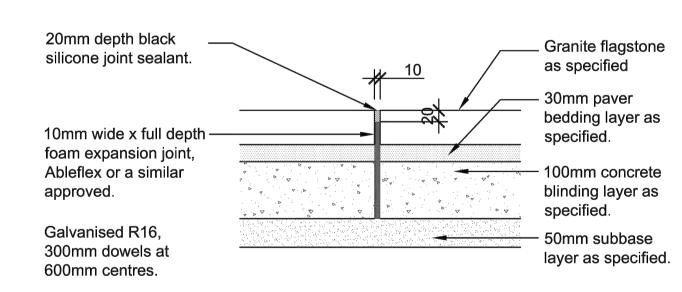

Detail 3e: Typical Isolation Joint Detail_Full Granite Treatment

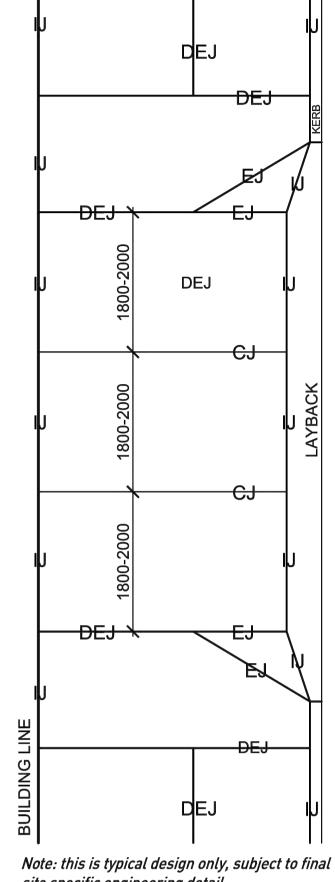

site specific engineering detail.

IJ - Isolation Joint

10mm wide x full depth foam expansion joint, Ableflex or form expansion joint to extend to 20mm below FFL to accommodate 20mm depth black silicone joint sealant. Refer to DS45_6c.

EJ - Expansion Joint

NOTE:

10mm wide x full depth subsurface foam expansion joint, Ableflex or similar approved. Finish foam expansion material 20mm below FFL to allow for 20mm depth black silicone joint sealant. Refer to DS45_6d. **DEJ - Dowelled Expansion Joint**

300mm long R16 galvanised dowels capped and installed at 600mm centres perpendicular to expansion joint and parallel to pavement centreline and finished surface. Use of proprietary sleeve may be required. Refer to DS45_6e.

CJ - Control Joints (in fibrecrete blinding layer) 3mm wide x 25mm deep sawcut control joint.

Detail 6b: Typical Concrete Joint Layout on Vehicle **Crossing - Secondary Granite Treatment**

TYPICAL DETAILS ARE TO BE

READ IN CONJUNCTION WITH

DETAILED CIVIL AND LANDSCAPING

FOR PROJECT SPECIFIC DETAILS.

2000 - 2400 2000 - 2400

Detail 5b: Typical Concrete Joint Layout on Footpath - Secondary Granite Treatment

2000 - 2400

BUILDING LINE

3600 4500 Tpy.

COUNCIL COMMENTS

COUNCIL COMMENTS

COUNCIL COMMENTS

Issue Description

MINOR ARCHITECTURAL AMENDMENTS

MINOR ARCHITECTURAL AMENDMENTS

2000 - 2400

Thickened Concrete edge Note: this is typical design only, subject to final site specific engineering detail.


30mm asphalt wearing course -Flagstone as specified. Max. 4mm AC7 hot mix asphalt as specified. shadow lines between stones. Details refer to DS45_2e. 80mm depth fibrecrete (25MPa) blinding layer as specified. 30mm Subsurface course - 3:1 10mm Isolation joint Thickened edge to match the sand/cement dry mortar bed topped with as specified. blinding layer under unit pavement. 1:1 cement/ 'Laticrete' slurry as specified. CONCRETE KERB & GUTTER 100mm depth fibrecrete (25MPa) blinding layer equivalent to SL82 as specified. Full depth dowelled expansion joir expressed through pavement 50mm depth DGB20 base course compacted between flagstone and asphalt to 100%MDD as specified. paving. Refer to detail DS45_6e.

Detail 5a: Typical Footpath Cross Section Secondary Granite Treatment


JAI | WSS | MBR **IDRAFT** 21/07/2017 | CAM | MBR **ARCHITECTS** 20/04/2017 | MBR | MBR | MBR MBR MBR Unit 43, 2 Slough Ave, MBR | MBR | MBR Silverwater NSW Drawn Design Checked PHONE: (02) 9648 8848

Designer Home Construction Pty Ltd

Parramatta City Council

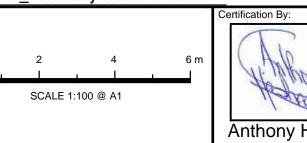



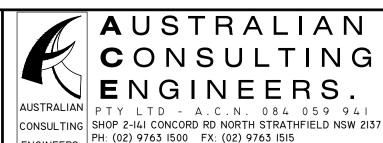

2-6 BOLD STREET & 80-82 COWPER STREET, GRANVILLE PROPOSED MIXED-USE DEVELOPMENT STORMWATER CONCEPT PLAN **DEVELOPMENT APPLICATION**

NOT FOR CONSTRUCTION

CONSTRUCTION NOTES AND DETAILS

ACE170865.SW.DA SK10 1:100

